


TRANSMITTAL

NUMBER:

CODE SHEET

	9-00-42-00-		VISTA Pro	jects Limited	
		VENDOR	DRAWING/DO	DCUMENT SQUAD CHE	CK
A	Reviewed without exception. Proceed with fabrication. Issue final drawings/ documents.				
В	Reviewed except as marked and/or noted. Proceed with fabrication and resubmit drawing/document. Shipment will not be released, if any drawings/documents requiring approval, as per purchase order conditions, are at this code.				
С	will not be re order condit	eleased, if ar ions, are at t	ny drawings/do his code.	esubmit drawing/docume cuments requiring appro	
D	Not required	for review.	Received for in	nformation.	
The endrawing	ngineer does ng/document i	not warrant o s either accu	or represent the	e design concept and speat the information contained. Sole responsibility for pmitting the drawing/documents.	ned on this correct design, detail
SD	OR CODE	EQUIPN	IENT TAG	REVIEWED BY	DATE
	DP-02	PKG	-600	4	JUN 2 6 2012
PRC	PROJECT NAME: Murphy Cadotte / 1780				
VEN	NDOR NA	AME:	Canadian Water Technologies / 1780-005		
DOCUMENT NUMBER: 16			1676-101		
VENDOR REVISION:		0			
	DOCUMENT DESCRIPTION:		Process & I	nstrumentation Diagra	m
VEN	NDOR				

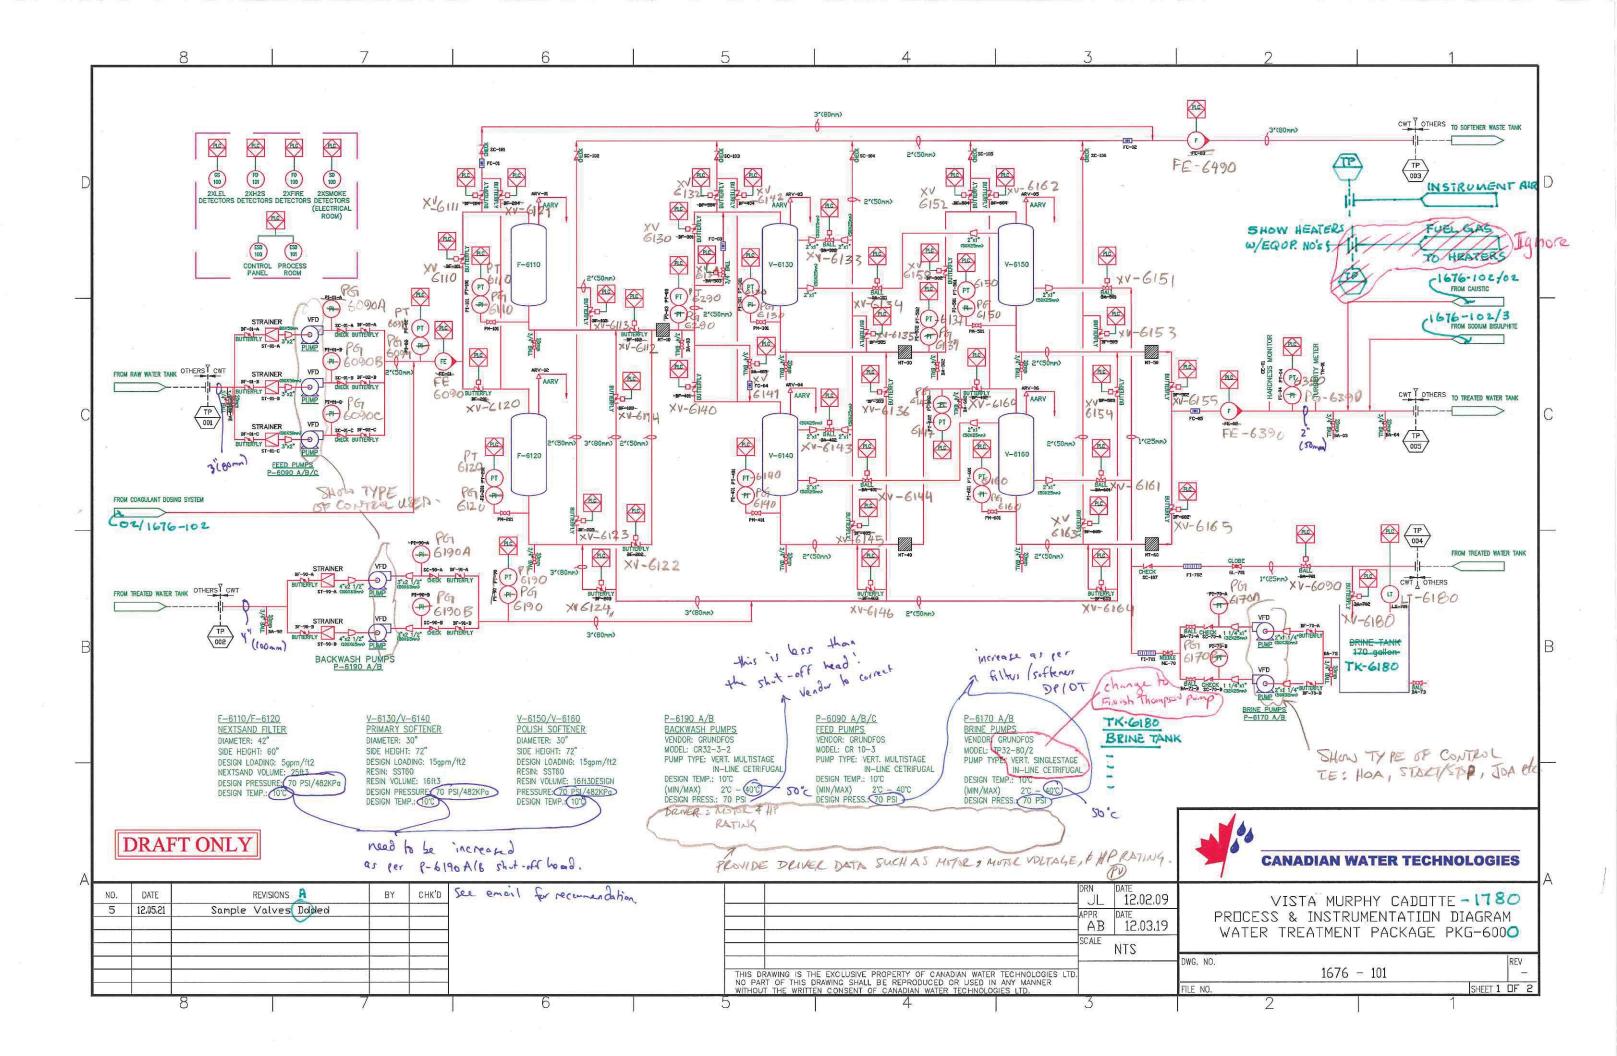



			VISTA Pro	jects Limited	
		VENDOR	DRAWING/DC	CUMENT SQUAD CHE	CK
Α	Reviewed w	rithout excep	tion. Proceed v	vith fabrication. Issue find	al drawings/ documents.
B	drawing/doo	Reviewed except as marked and/or noted. Proceed with fabrication and resubmit drawing/document. Shipment will not be released, if any drawings/documents requiring approval, as per purchase order conditions, are at this code.			
С	will not be re		ny drawings/doo	esubmit drawing/docume cuments requiring appro	ent for review. Shipment val, as per purchase
D	Not required	for review.	Received for in	formation.	
The er	igineer does	nor warrant	or represent tha	ar the information contair	
drawin and dir	g/document i mensions sha	is either acci all remain wi	urate or comple th the party sub	at the information contain ete. Sole responsibility for emitting the drawing/docu	r correct design, detail ument.
drawin and dir	g/document i	is either acci all remain wi EQUIPN	urate or comple	te. Sole responsibility fo	r correct design, detail
drawin and dir SD	g/document i mensions sha R CODE	is either acci all remain wi EQUIPI PKG	urate or completh the party sub	te. Sole responsibility fo mitting the drawing/docu	r correct design, detail ument. DATE
drawin and dir	g/document imensions shaper CODE DP02	is either accial remain with EQUIPM PKG AME:	Murphy Ca	ete. Sole responsibility for mitting the drawing/documentation of the drawing of	DATE JUN 2 6 2012


VENDOR
REVISION:

0

DOCUMENT
DESCRIPTION:
Process & Instrumentation Diagram

VENDOR
TRANSMITTAL


NUMBER: 120605Trans09

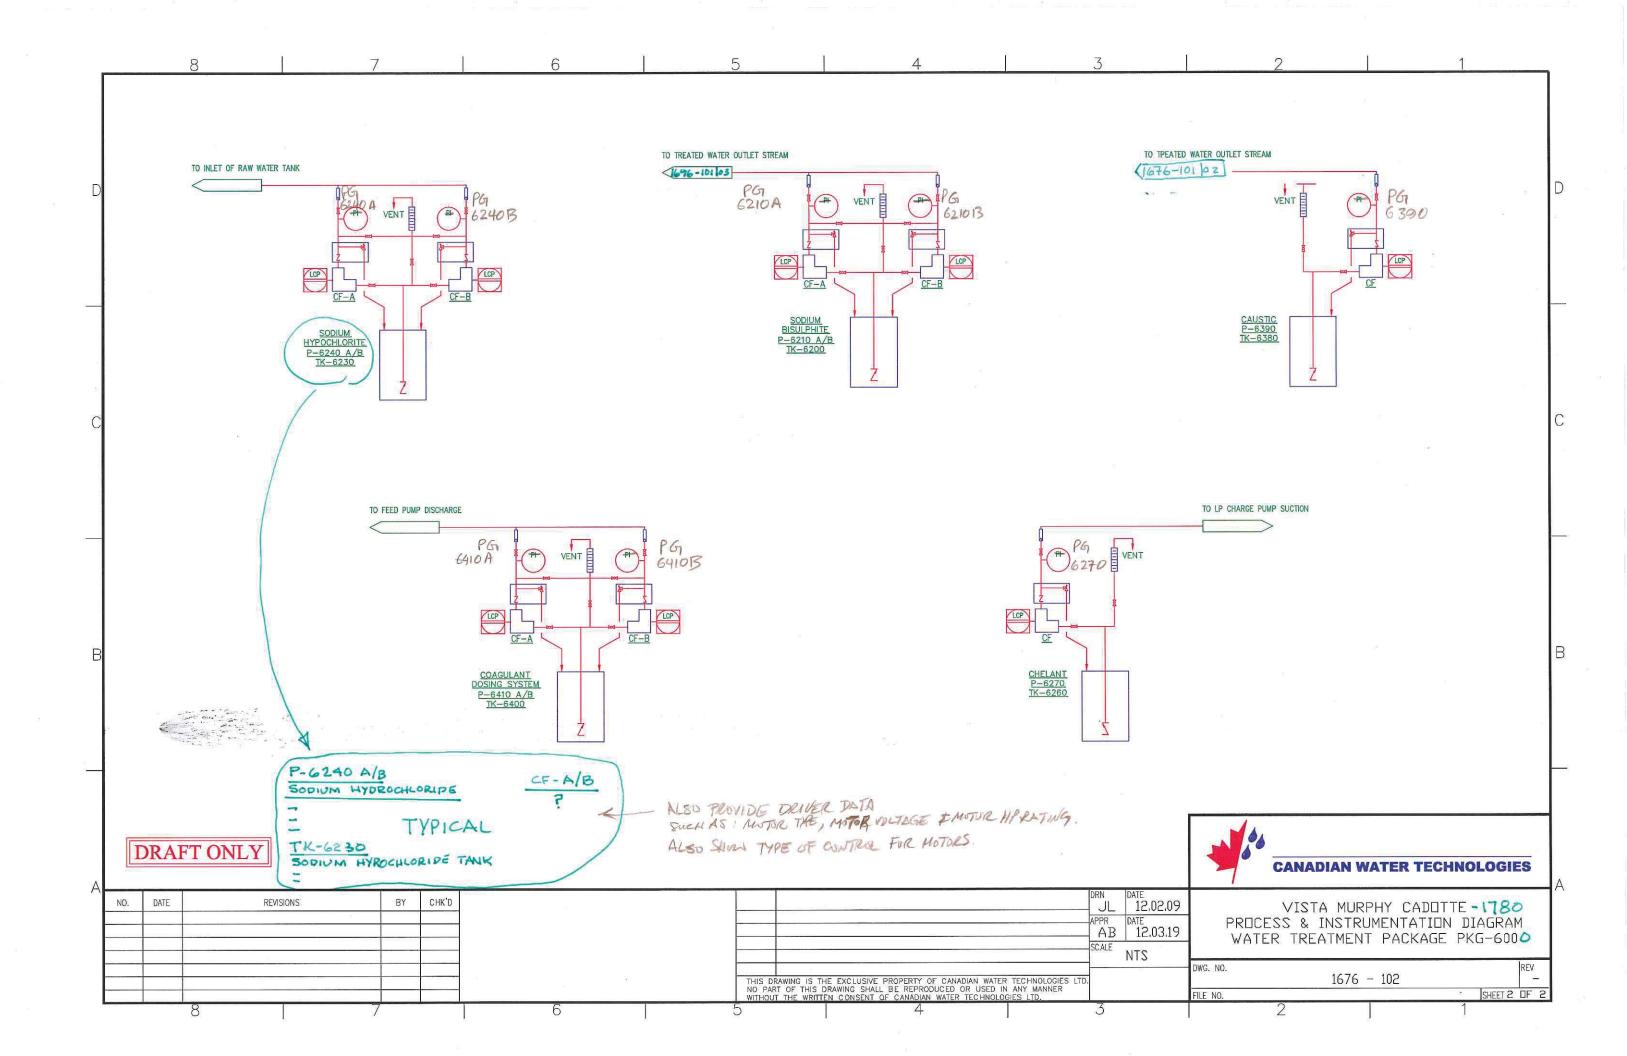



VISTA Projects Limited


			Jecis Ellillieu			
	110411011111111111111111111111111111111		CUMENT SQUAD CHE			
A Reviewed v	Reviewed without exception. Proceed with fabrication. Issue final drawings/ documents.					
drawing/doo	Reviewed except as marked and/or noted. Proceed with fabrication and resubmit drawing/document. Shipment will not be released, if any drawings/documents requiring approval, as per purchase order conditions, are at this code.					
will not be r		ny drawings/doo	esubmit drawing/docume cuments requiring appro			
D Not require	d for review.	Received for in	formation.			
The engineer does drawing/document	not warrant of is either accu	or represent that urate or comple	e design concept and sp at the information contain ete. Sole responsibility for emitting the drawing/docu	ned on this r correct design, detail		
SDR CODE DM01		IENT TAG	REVIEWED BY	JUN 2 6 2012		
PROJECT N	50 P30 00 00 00 00 00 00 00 00 00 00 00 00 0		ndotte / 1780 Water Technologies / 1	780-005		
DOCUMENT NUMBER:		1676-201				
VENDOR REVISION:		0				
DOCUMENT DESCRIPTION		General Ass	sembly Water Treatme	ent Package PKG-6000		
VENDOR TRANSMIT NUMBER:	ΓAL	120605Trar	ns09			

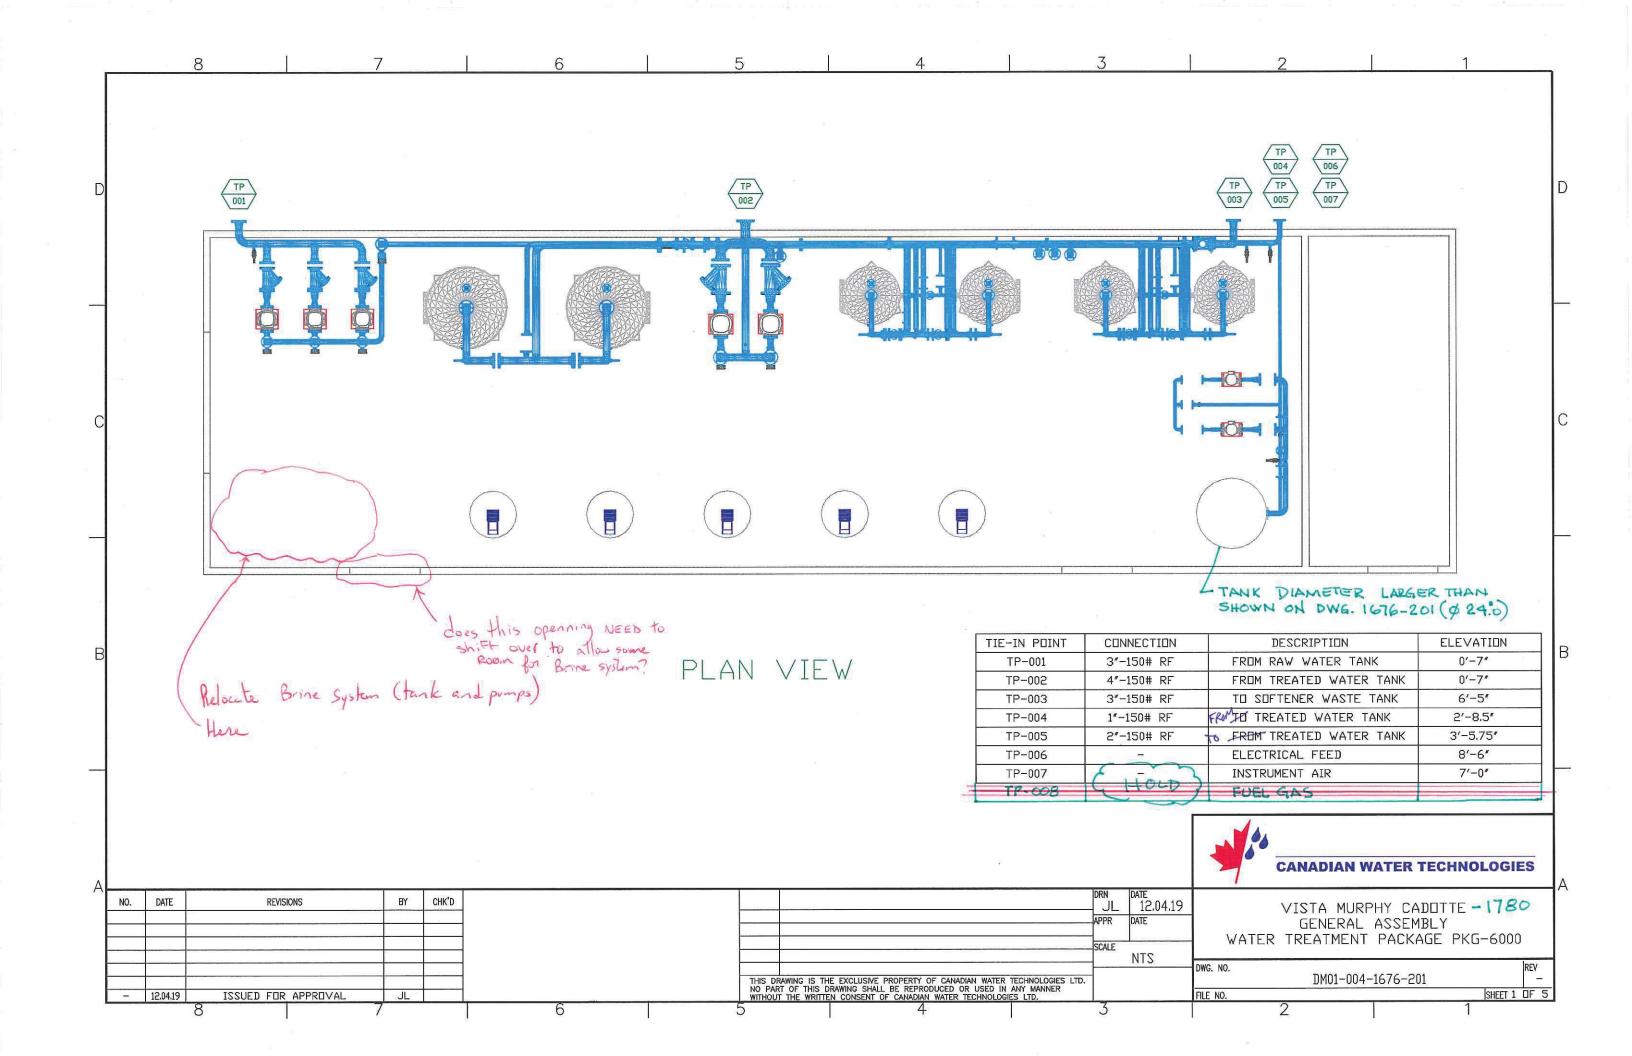



VISTA Projects Limited


				10010		
	#	BORNE IN CONTRACTOR	TOWNS AND ADDRESS OF THE PARTY.	DOUMENT SQUAD CHE		
A	Reviewed without exception. Proceed with fabrication. Issue final drawings/ documents.					
В	drawing/doo	ument. Ship	ment will not b	ted. Proceed with fabrica be released, if any drawing tions, are at this code.		
С	will not be re		y drawings/do	esubmit drawing/docume cuments requiring appro-		
D	Not required	d for review. I	Received for in	nformation.		
The er	ngineer does ig/document i	not warrant o	or represent the	ne design concept and sp at the information contain ete. Sole responsibility for bmitting the drawing/docu	ned on this recorrect design, detail	
SD	R CODE	EQUIPN	IENT TAG	REVIEWED BY	DATE	
	DM-01	PKG	-6000		JUN 2 6 2012	
	DJECT NA			adotte / 1780 Water Technologies / 1	790 005	
DO	CUMENT MBER:		1676-201-		780-003	
VENDOR REVISION:			0		NAMES OF THE OWNER, THE	
100000000000000000000000000000000000000	CUMENT CRIPTIC		Proposed I	_ayout		
TRA	NDOR ANSMIT MBER:	ΓAL	120605Tra	ns09		

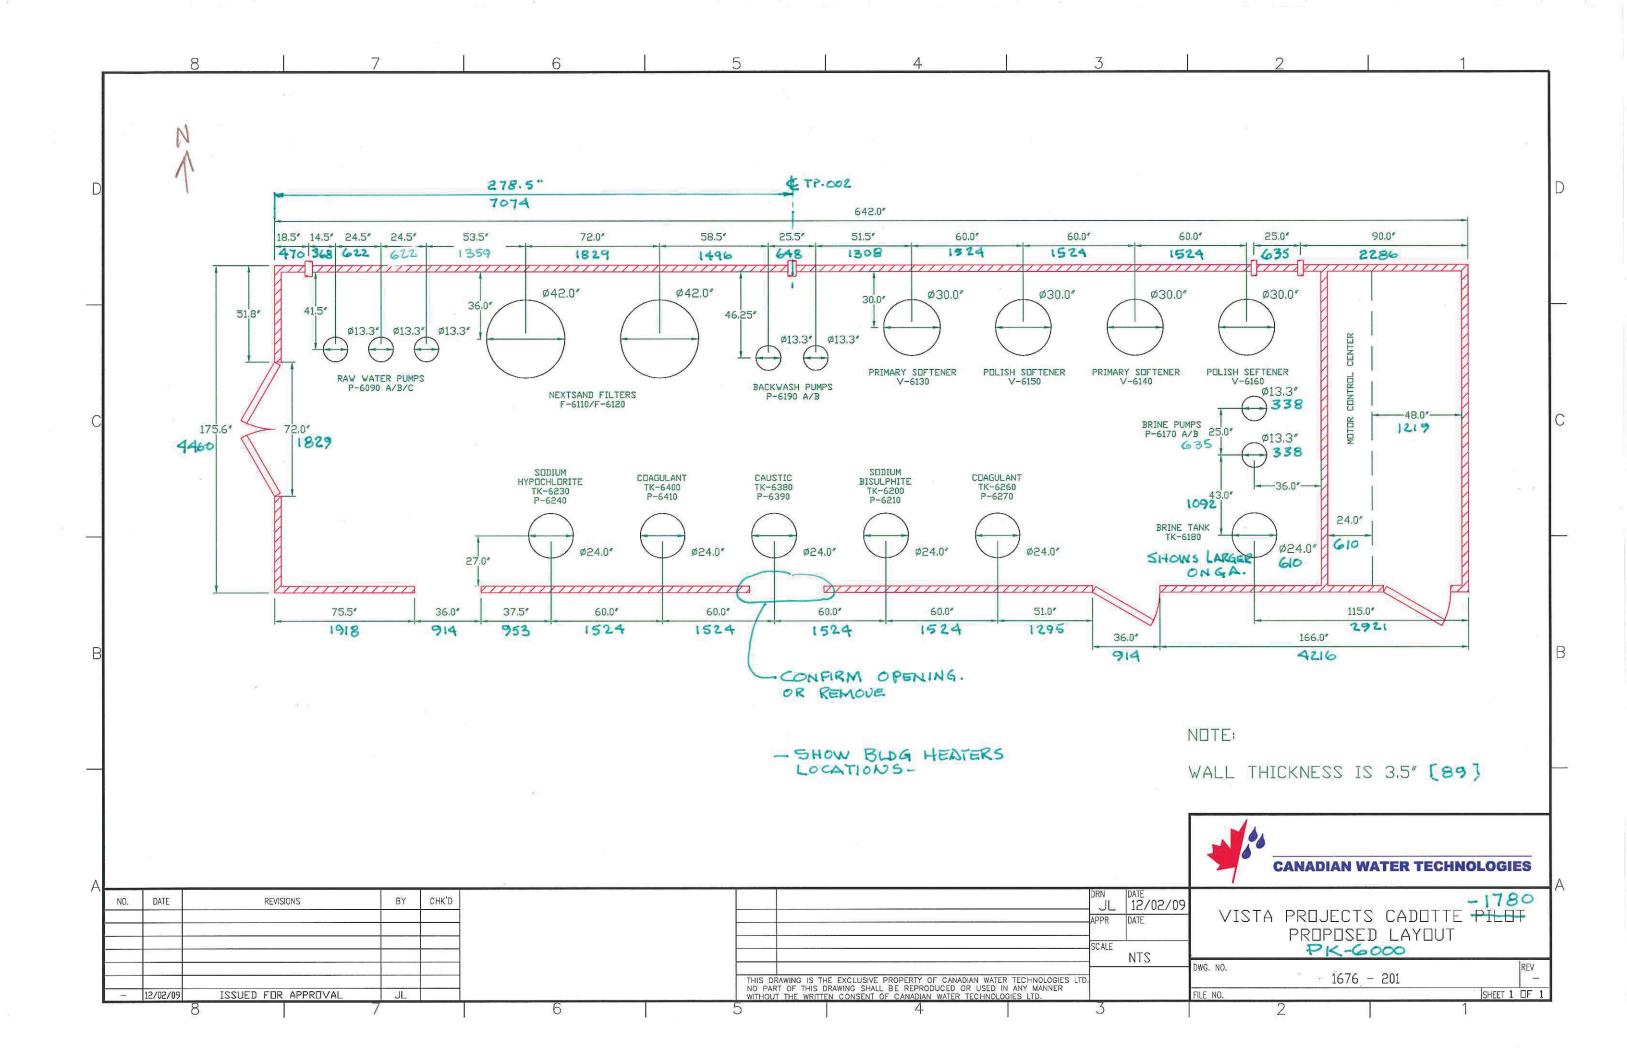




		VISTA Pro	jects Limited		
		VENDOR DRAWING/DO	CUMENT SQUAD CHE	ECK	
A	Reviewed w	ithout exception. Proceed v	vith fabrication. Issue fir	nal drawings/ documents	
B	drawing/doc	xcept as marked and/or not ument. Shipment will not be per purchase order condit	e released, if any drawir		
С	will not be re	d. Revise as marked and re eleased, if any drawings/do- ions, are at this code.			
D	Not required for review. Received for information.				
The e	ngineer does ng/document i	general conformity with the not warrant or represent the seither accurate or comple all remain with the party sub	at the information contained. Sole responsibility for	ined on this or correct design, detail	
SDR CODE DM01		EQUIPMENT TAG DV (5-1-0101)	REVIEWED BY	DATE JUN 2 6 2012	

PROJECT NAME:	Murphy Cadotte / 1/80
VENDOR NAME:	Canadian Water Technologies / 1780-005
DOCUMENT NUMBER:	1676-202
VENDOR REVISION:	0
DOCUMENT DESCRIPTION:	General Assembly Water Treatment Package PKG-6000
VENDOR TRANSMITTAL NUMBER:	120605Trans09

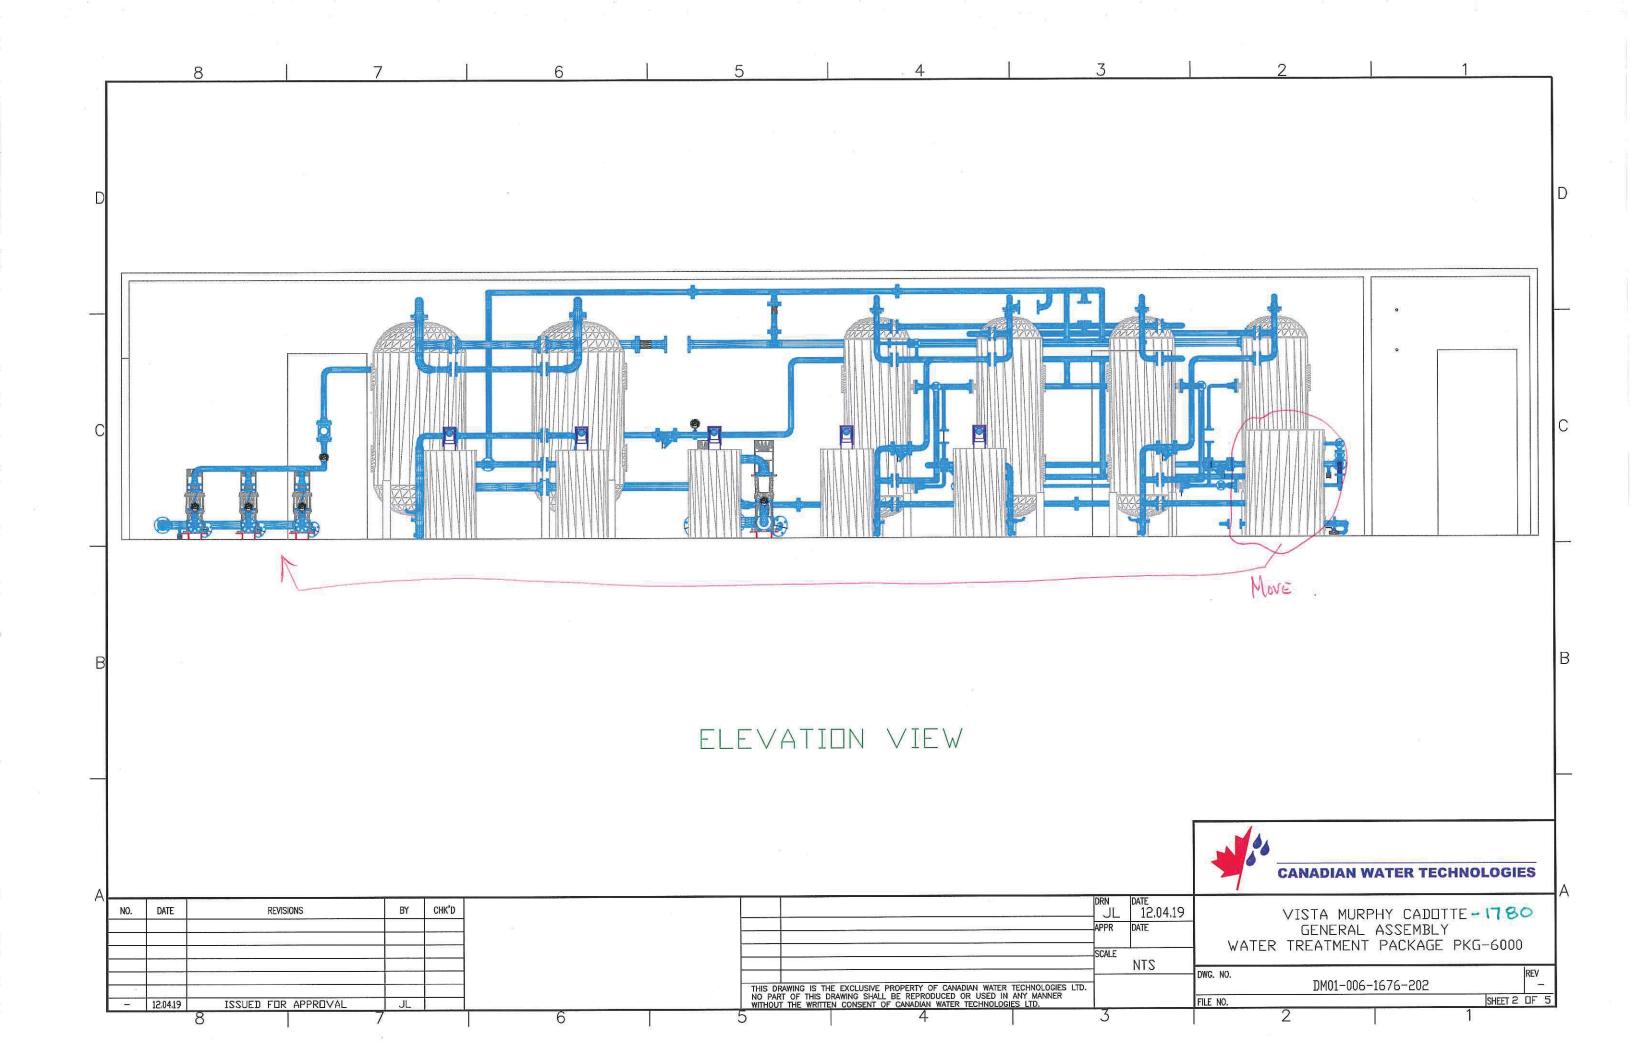



				jects Limited		
8				DCUMENT SQUAD CHE		
A	Reviewed w	Reviewed without exception. Proceed with fabrication. Issue final drawings/ documents.				
B	Reviewed except as marked and/or noted. Proceed with fabrication and resubmit drawing/document. Shipment will not be released, if any drawings/documents requiring approval, as per purchase order conditions, are at this code.					
С	A THE RESIDENCE OF THE PARTY OF	eleased, if a	ny drawings/do	esubmit drawing/docum cuments requiring appro	ent for review. Shipment oval, as per purchase	
D	Not required	for review.	Received for in	formation.		
The endrawing	ngineer does ng/document i	not warrant s either acc	or represent the urate or comple	e design concept and sp at the information contai ete. Sole responsibility fo omitting the drawing/doc	ned on this or correct design, detail	
SE	OR CODE	EQUIPI	MENT TAG	REVIEWED BY	DATE	
	DM01	PKG	-6000	P	2012-06-26	
37000 SERVICES	DJECT NA	614 TO 100 TO 100		adotte / 1780 Water Technologies / :	1780-005	
	CUMENT MBER:		1676-203			
	NDOR /ISION:		0	8	2 - 12 - 12 - 12 - 12 - 12 - 12 - 12 -	
	CUMENT SCRIPTIO		General As	sembly Water Treatm	ent Package PKG-6000	
TRA	NDOR ANSMITT MBER:	ΓAL	120605Tra	ns09		

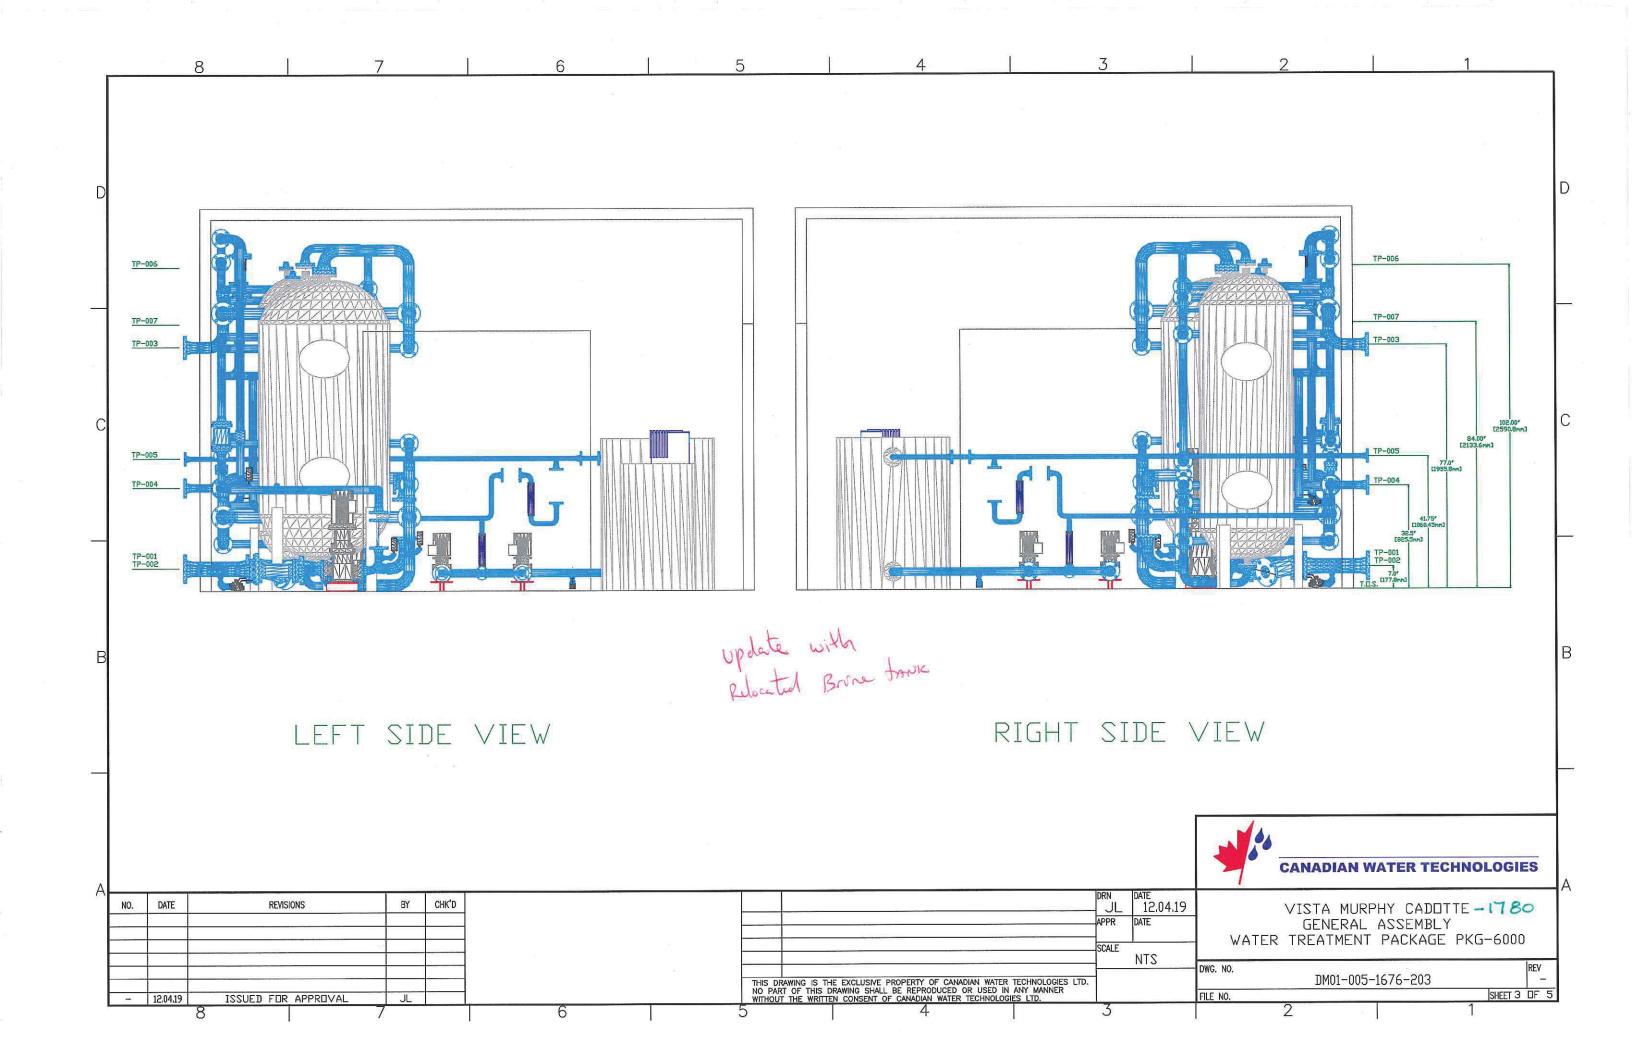




TRANSMITTAL

NUMBER:

CODE SHEET


			jects Limited			
			DCUMENT SQUAD CHE			
A Reviewed v	Reviewed without exception. Proceed with fabrication. Issue final drawings/ documents.					
drawing/doo	cument. Ship	ment will not b	ted. Proceed with fabrica e released, if any drawin ions, are at this code.			
will not be r		ny drawings/do	esubmit drawing/docume cuments requiring appro	and the second s		
Not require	d for review.	Received for in	formation.			
The engineer does drawing/document	not warrant of is either accu	or represent the	e design concept and sp at the information contain ete. Sole responsibility fo pmitting the drawing/docu	ned on this r correct design, detail		
SDR CODE	EQUIPN	IENT TAG	REVIEWED BY	DATE		
DM01	PKG	-6000	DL_	JUN 2 6 2012		
PROJECT N	AME:	Murphy Ca	adotte / 1780			
VENDOR N.	AME:	Canadian Water Technologies / 1780-005				
DOCUMEN' NUMBER:	Γ	1676-204				
VENDOR REVISION:		0				
DOCUMENT DESCRIPTION		General As	sembly Water Treatme	ent Package PKG-6000		
VENDOR						

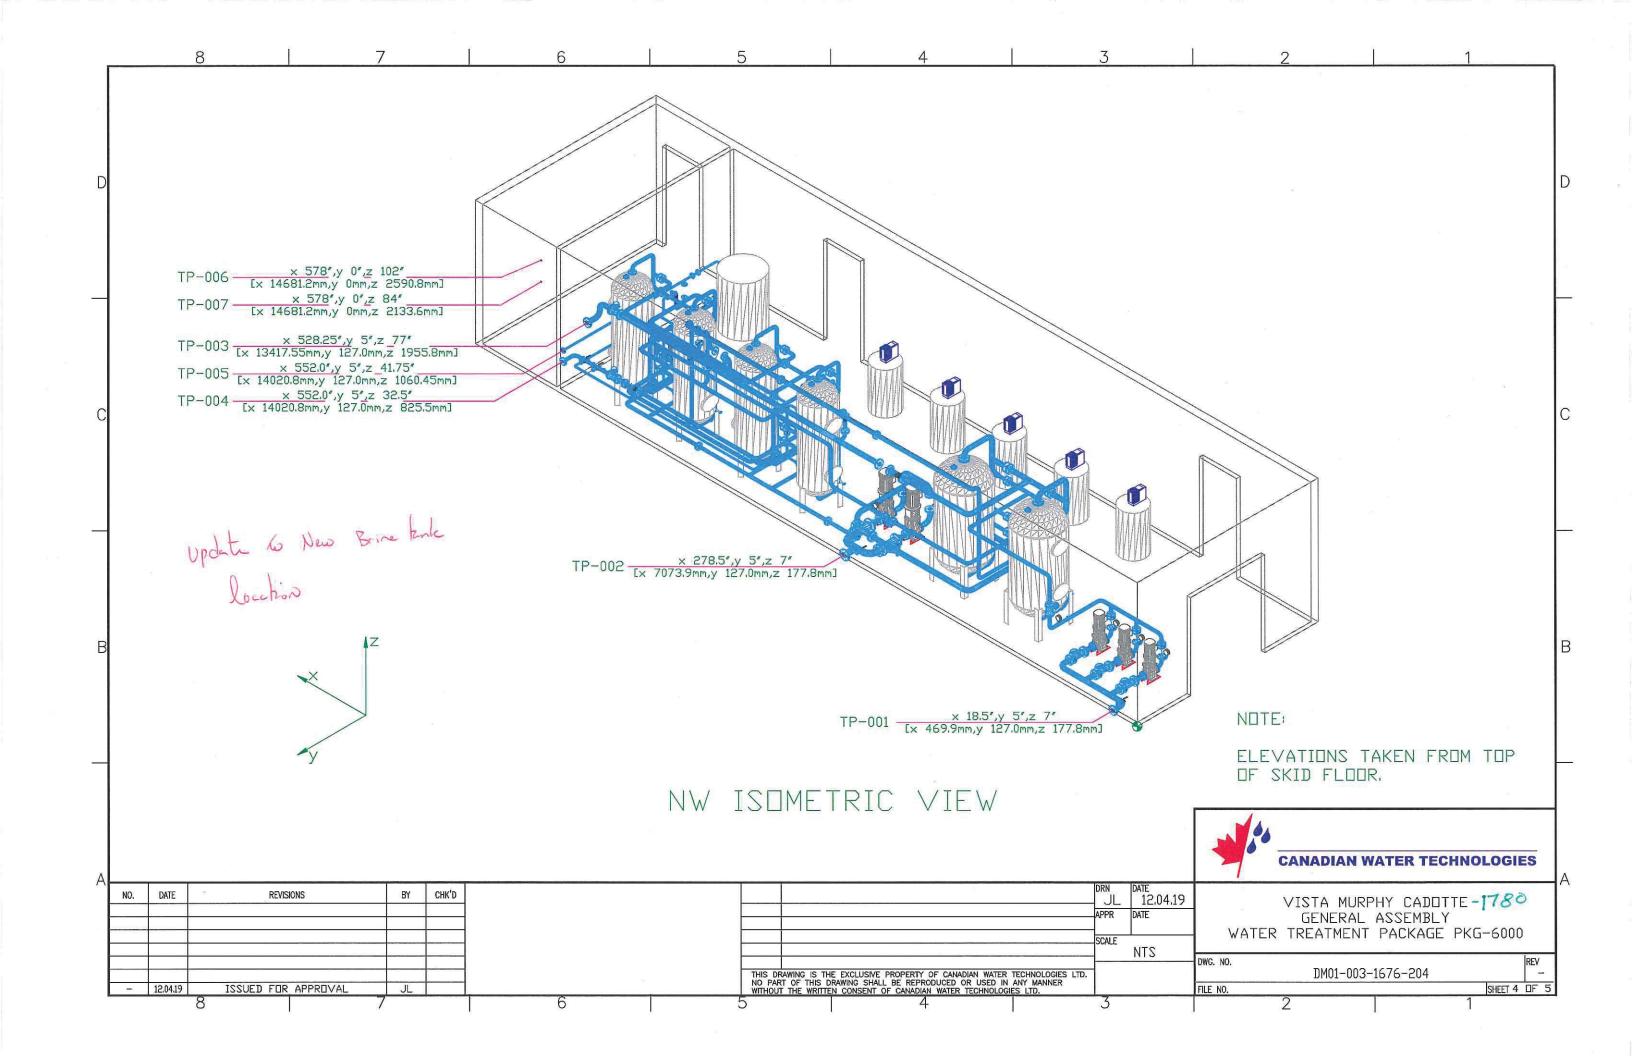



			VISTA Proj	ects Limited	
		VENDOR		CUMENT SQUAD CHE	CK
Α	Reviewed w	ithout excep	otion. Proceed w	ith fabrication. Issue fin	al drawings/ documents
B	Reviewed except as marked and/or noted. Proceed with fabrication and resubmit drawing/document. Shipment will not be released, if any drawings/documents requiring approval, as per purchase order conditions, are at this code.				
C	Not accepted. Revise as marked and resubmit drawing/document for review. Shipment will not be released, if any drawings/documents requiring approval, as per purchase order conditions, are at this code.				
D	Not required for review. Received for information.				
The er	ngineer does ng/document i	not warrant s either acc	or represent tha urate or comple	e design concept and sp at the information contain te. Sole responsibility fo mitting the drawing/docu	ned on this or correct design, detail
Li .		WENT TAG	REVIEWED BY	JUN 2 6 2012	
PRC	JECT NA	AME:	Murphy Ca	dotte / 1780	
VENDOR NAME:		Canadian V	Vater Technologies / 2	1780-005	
	CUMENT	Γ	1676 205		

VENDOR NAME:	Canadian Water Technologies / 1780-005
DOCUMENT NUMBER:	1676-205
VENDOR REVISION:	0
DOCUMENT DESCRIPTION:	General Assembly Water Treatment Package PKG-6000
VENDOR TRANSMITTAL NUMBER:	120605Trans09

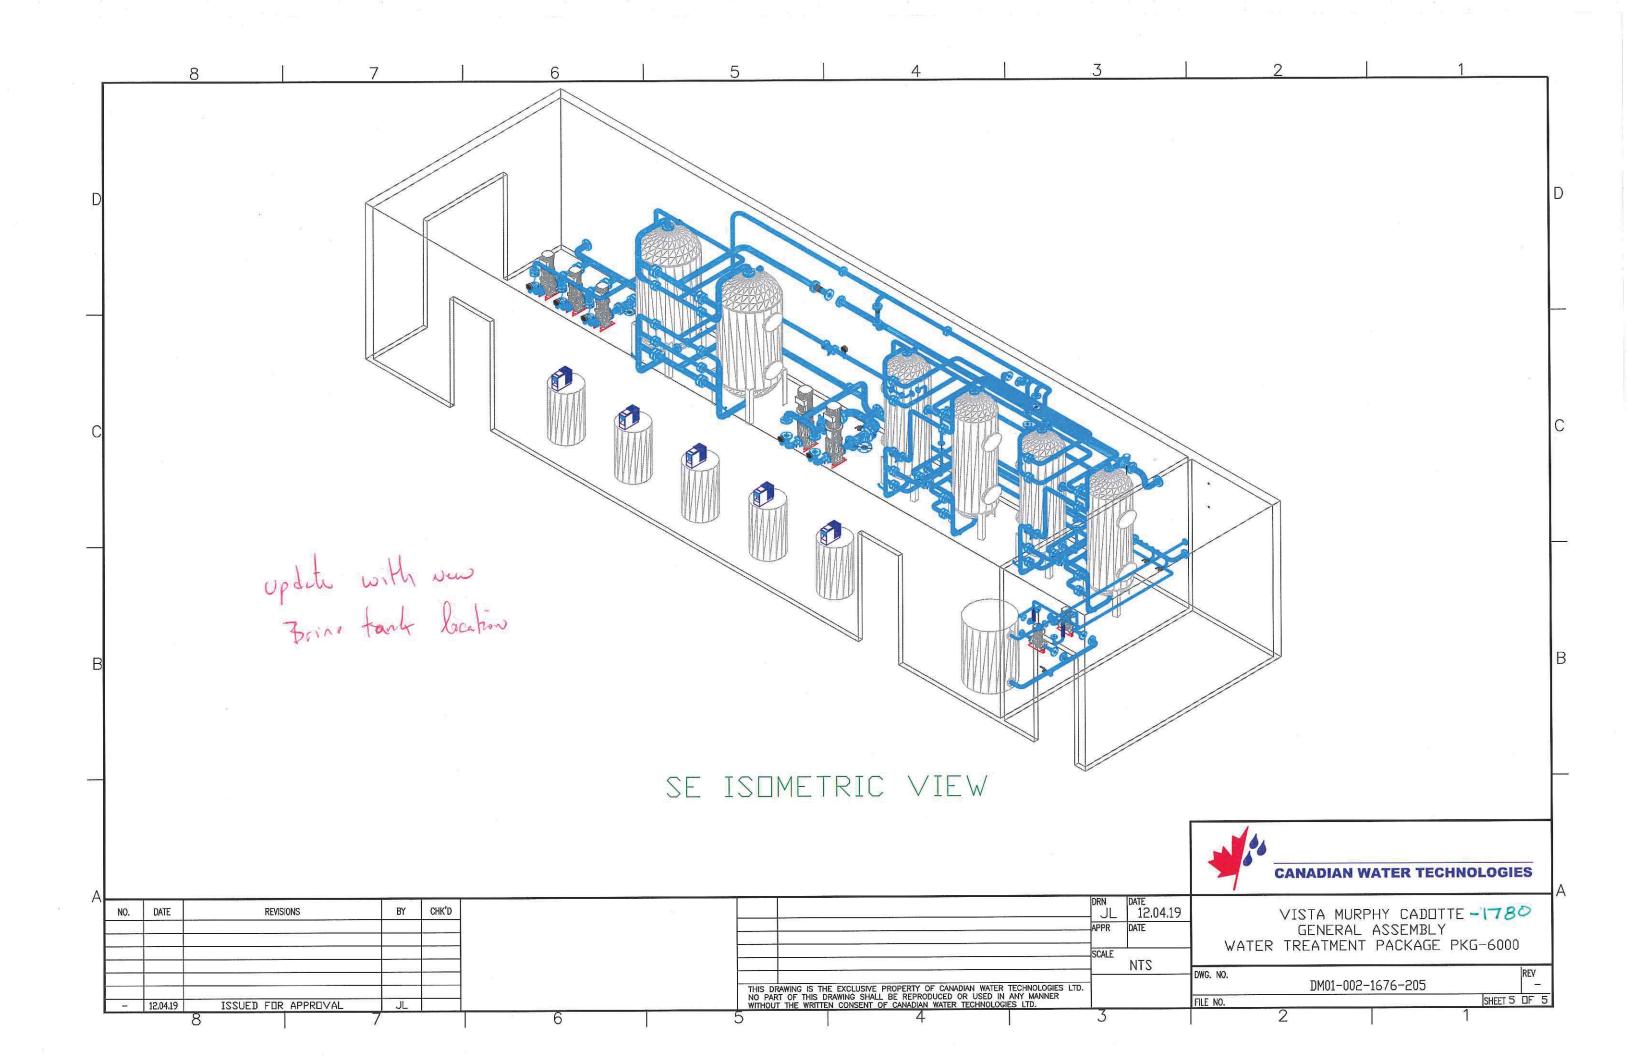




NUMBER:

CODE SHEET

			VISTA Pro	jects Limited		
		VENDOR	DRAWING/DO	DCUMENT SQUAD CHE	CK	
A	Reviewed w	Reviewed without exception. Proceed with fabrication. Issue final drawings/ documents.				
В	drawing/doc	ument. Ship	ment will not b	ted. Proceed with fabrica e released, if any drawin ions, are at this code.		
C	will not be re		ny drawings/do	esubmit drawing/docume cuments requiring appro		
D	Not required	for review.	Received for in	nformation.		
The endrawing	ngineer does ng/document i	not warrant o	or represent the	e design concept and sp at the information contair ete. Sole responsibility for pmitting the drawing/docu	ned on this r correct design, detail	
SE	OR CODE	EQUIPN	IENT TAG	REVIEWED BY	DATE	
	DP02	PKE	7-6000	91_	JUN 2 3 2012	
	DJECT NA NDOR NA			adotte / 1780 Water Technologies / 1	780-005	
DOCUMENT NUMBER:			1676-801			
VENDOR REVISION:			0			
DOCUMENT DESCRIPTION:			Process & I	nstrumentation Diagra	m Legend	
ii ee aa	NDOR ANSMITT	ΓAL				

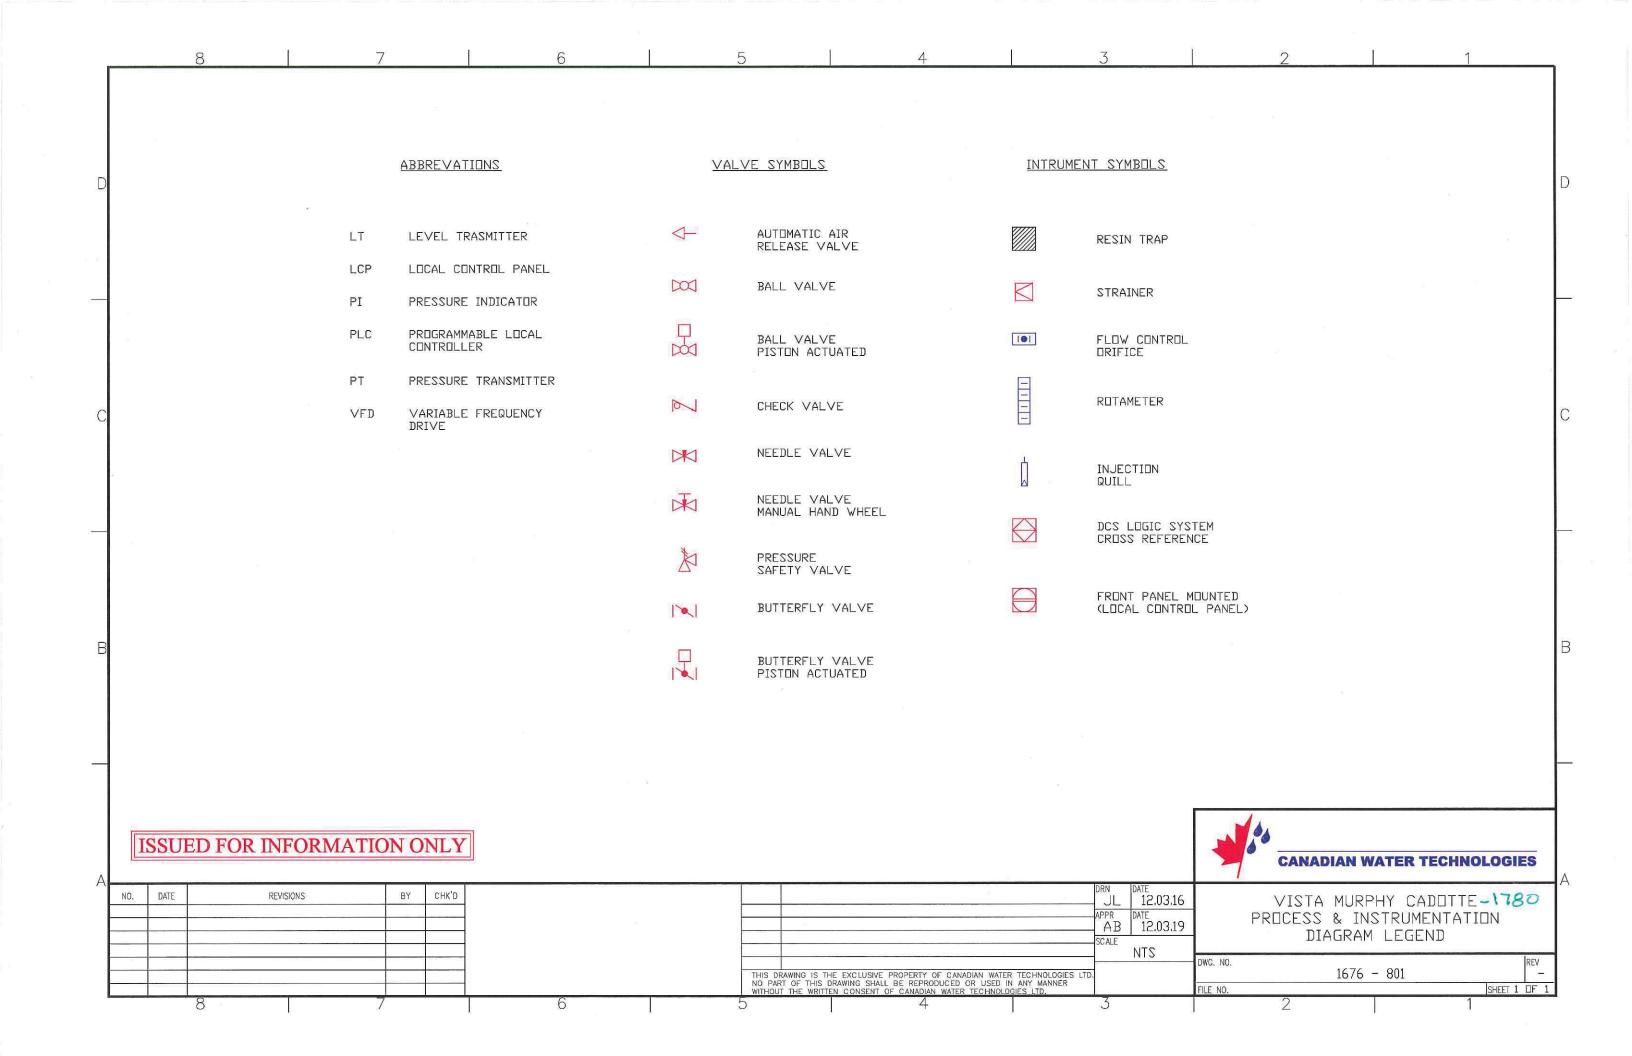



	VIS	TA Projects Limited	<u> </u>			
	VENDOR DRAW	ING/DOCUMENT SQ	UAD CHECK			
A	Reviewed without exception. Proceed with fabrication. Issue final drawings/documents.					
B)	Reviewed except as marked and/or noted. Proceed with fabrication and resubmit drawing/document. Shipment will not be released, if any drawings/documents requiring approval, as per purchase order conditions, are at this code.					
С						
D						
The eng	ed only as to general conform pineer does not warrant or rep /document is either accurate on d dimensions shall remain wi	resent that the information complete. Sole resp	consibility for correct design,			
SDR C			DATE 2012-04-30			

PROJECT NAME: Murphy Oil Cadotte 1780-005

VENDOR NAME: Canadian Water Technologies

DOCUMENT

NUMBER: 4488-ELC-0001-1

VENDOR

REVISION: A

DOCUMENT

DESCRIPTION: <u>Drawing List</u>

VENDOR TRANSMITTAL

NUMBER: 120418Trans05

GROUP	DRAWING NUMBER	DRAWING LIST DESCRIPTION
State of the state	0001	DRAWING LIST (1 DF 2)
A. COVER	0002	STANDARD ELECTRICAL DETAIL (2 DF 2)
* S	0010	BUILDING LIGHTING LAYDUT (1 DF 6)
	0011	BUILDING EMERGENCY LIGHTING LAYOUT (2 DF 6)
	0012	BUILDING HEATER LAYOUT (3 DF 6)
B, BUILDING LAYOUTS -	0013	BUILDING PANEL LOCATION LAYOUT (4 OF 6)
- n	0014	BUILDING INSTRUMENTATION LAYOUT (5 OF 6)
- B	0015	BUILDING HAZARDOUS LOCATION LAYOUT (6 OF 6)
9	0050	LOAD LIST (1 OF 8)
⊕ 30 ⊈	0060 - 0062	CABLE SCHEDULE (2-4 DF 8)
C. POWER	0070	PANEL SCHEDULE (5 DF 8)
	0080 - 0081	SINGLE LINE DIAGRAM (6-7 DF 8)
	0100	THREE LINE DIAGRAM (8 DF 8)
	1000 - 1050	CONTROL POWER WIRING DIAGRAM (1-2 OF 17)
, ,	2000 - 2050	DISCRETE INPUT WIRING DIAGRAM (3-4 OF 17)
27	3000 - 3050	DISCRETE DUTPUT WIRING DIAGRAM (5-6 DF 17)
	4000 - 4050	ANALOG INPUT WIRING DIAGRAM (7-9 OF 17)
	5000	ANALOG DUTPUT WIRING DIAGRAM (10 OF 17)
D. CONTROLS -	6000	COMMUNICATIONS DIAGRAM (11 OF 17)
	6001	STANDARD VFD WIRING DIAGRAM (12 DF 17)
5	7000	480VAC JUNCTION BOX WIRING DIAGRAM (13 OF 17)
-	7001 - 7002	120VAC JUNCTION BOX WIRING DIAGRAM (14-15 OF 17)
N	7003 - 7004	CONTROL JUNCTION BOX WIRING DIAGRAM (16-17 OF 17)
x	8000	CONTROL PANEL LAYOUT (1 DF 7)
	8001	MCC PANEL LAYOUT (2 DF 7)
±	8002	CONTROL PANEL BILL OF MATERIAL (3 OF 7)
LAYOUT AND BILL OF	8003	
MATERIAL	7 7 7 7	MCC PANEL BILL OF MATERIAL (4 OF 7)
5	8004	480VAC JUNCTION BOX LAYOUT AND BILL OF MATERIAL (5 OF 7)
α .	8005	120VAC JUNCTION BOX LAYOUT AND BILL OF MATERIAL (6 OF 7)
2	8006	CONTROL JUNCTION BOX LAYOUT AND BILL OF MATERIAL (7 OF 7

NOTES:

NUMBERS PLECEDED

BY:
4488-ELC-XXXX



-			
		(a)	
Α	27/03/12	ISSUED FOR APPROVAL	PZC
REV	DATE	DESCRIPTION	BY

APPROVED

NAME DATE

TR TQUEST SERVICES LTD € ELECTRICAL CONTRACTING - AUTOMATION & CONTROLS

BAY 11 3716 56AVE S.E. CALGARY, AB T2C-2B5

SCALE	NTS	
DESIGNED	PZC	
DRAWN	PZC	
CHECKED	LT	
DATE	MARCH, 2012	

MURPHY OIL CADOTTE CSS PILOT WTP

DRAWING TITLE

DRAWING

LIST

DRAWING GROUP A	SHEET	1	DF	2	REV
DRAWING NUMBER			DWG	SIZE	Α
4488-ELC-0001			11:	×17	



	VIS	TA Projects Limited	
	VENDOR DRAW	ING/DOCUMENT SO	QUAD CHECK
A	Reviewed without exception documents.	. Proceed with fabrica	ation. Issue final drawings/
В		nt will not be released	ed with fabrication and resubmit , if any drawings/documents ons, are at this code.
С	Not accepted. Revise as ma Shipment will not be release per purchase order condition	d, if any drawings/doo	awing/document for review. cuments requiring approval, as
D)	Not required for review. Rec		
The end	red only as to general conform gineer does not warrant or rep g/document is either accurate and dimensions shall remain wi	resent that the inform or complete. Sole res	ponsibility for correct design,
SDR (CODE EQUIPMENT TAG	REVIEWED BY	DATE
DE	199 PKG-6000	2	2012-04-30

PROJECT NAME: Murphy Oil Cadotte 1780-005

VENDOR NAME: Canadian Water Technologies

DOCUMENT

NUMBER:

4488-ELC-0002-2

VENDOR

REVISION:

A


DOCUMENT

DESCRIPTION:

Standard Electrical Detail

VENDOR TRANSMITTAL

NUMBER:

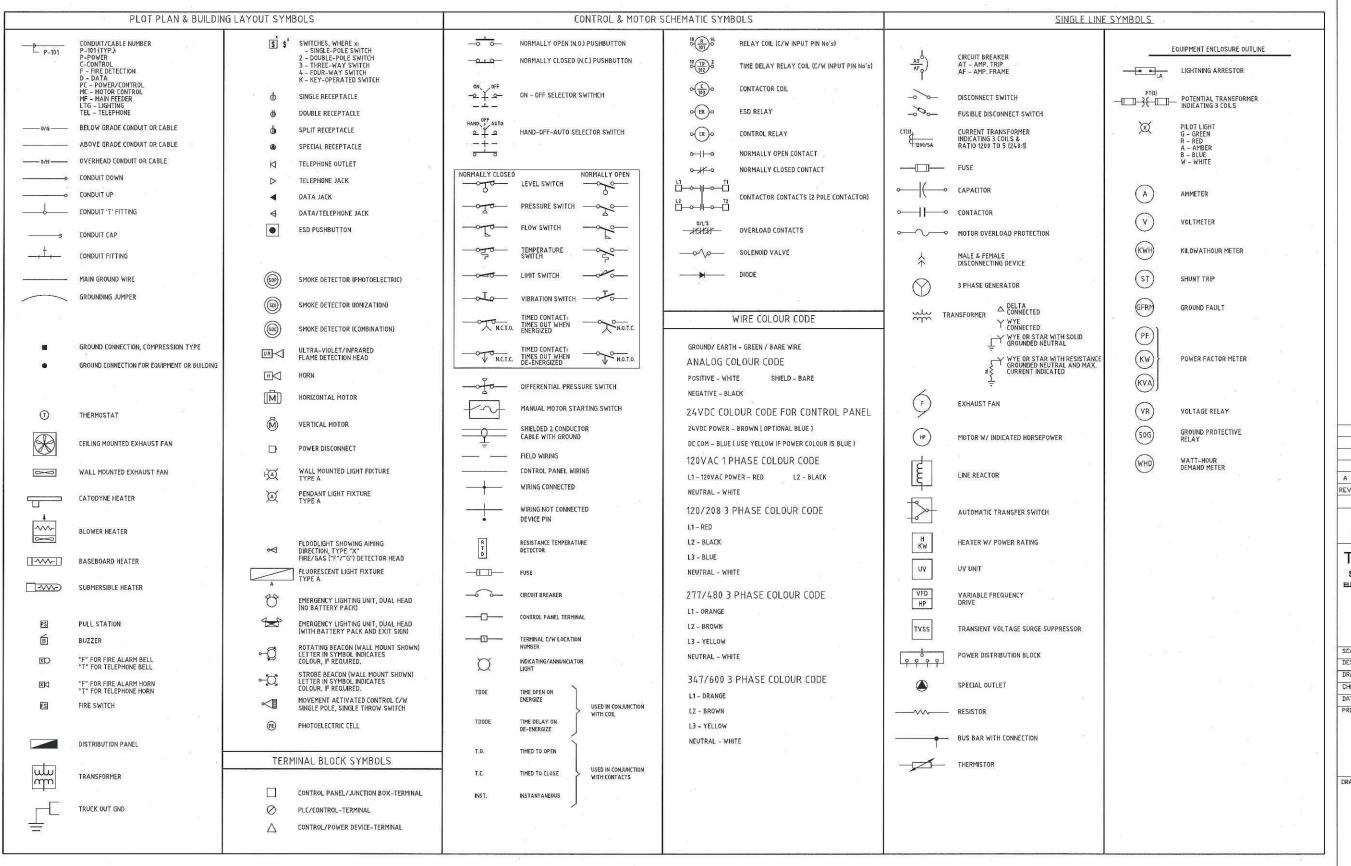

A 27/03/12 ISSUED FOR APPROVAL PZC
REV DATE DESCRIPTION BY
REVISIONS
APPROVED
NAME DATE

TR TQUEST SERVICES LTD = ELECTRICAL CONTRACTING - AUTOMATION & CONTROLS

BAY 11 3716 56AVE S.E. CALGARY, AB T2C-2B5

NTS	
PZC	
PZC	
LT	
MARCH, 2012	
	PZC PZC LT

MURPHY OIL CADOTTE CSS PILOT WTP

DRAWING TITLE

STANDARD ELECTRICAL DETAIL

DRAWING GROUP A	SHEET	2 or 2	REV
DRAWING NUMBER		DWG SIZE	Α
4488-ELC-0002		11×17	



			A Projects Limited	
Α	Review	wed without exception.		ation. Issue final drawings/
B	drawin		will not be released	ed with fabrication and resubmit I, if any drawings/documents ons, are at this code.
С	Shipm		, if any drawings/do	awing/document for review. cuments requiring approval, as
D	Not re	quired for review. Rece	ived for information.	
The er	ngineer do g/docum	oes not warrant or repre ent is either accurate or	esent that the inform complete. Sole res	ncept and specifications provided. nation contained on this ponsibility for correct design, of the drawing/document.
	CODE	EQUIPMENT TAG	REVIEWED BY	DATE
DE	02	PKG-6000	Demon	2012 -04 - 30

PROJECT NAME: Murphy Oil Cadotte 1780-005

VENDOR NAME: Canadian Water Technologies

DOCUMENT

NUMBER:

4488-ELC-0010-1

VENDOR

REVISION:

<u>A</u>

DOCUMENT


DESCRIPTION:

Building Lighting Layout

VENDOR

TRANSMITTAL

NUMBER:

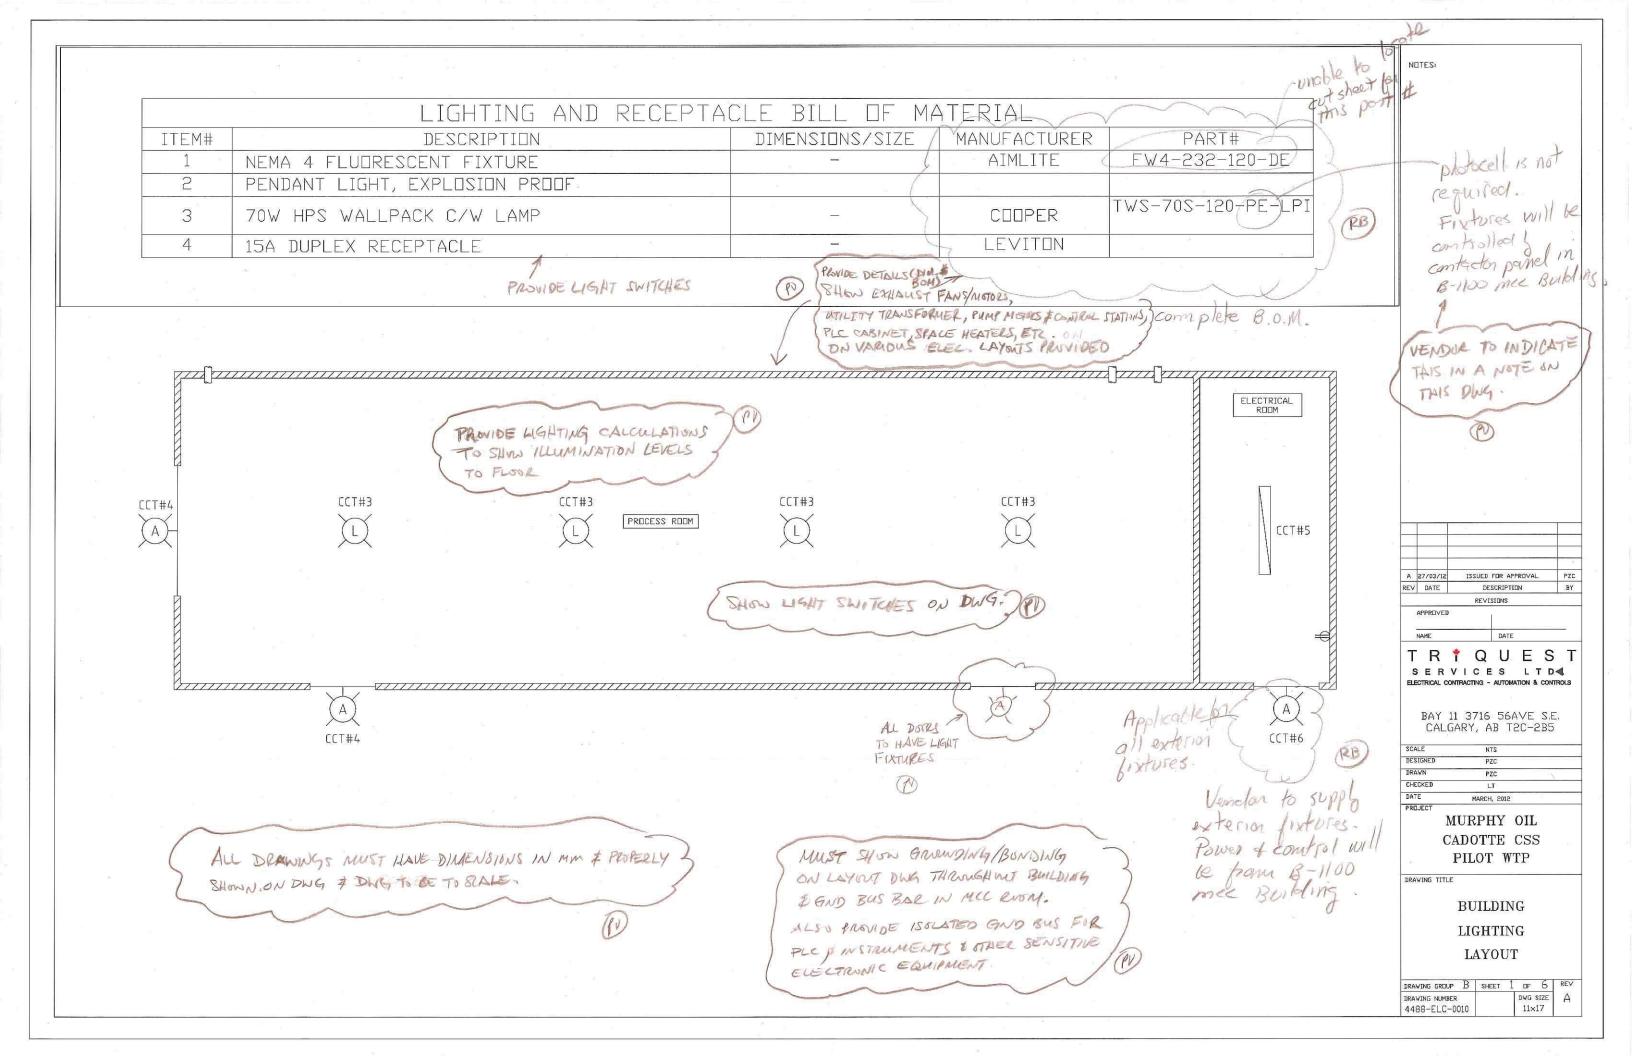



	VIS	TA Projects Limited	
	VENDOR DRAW	ING/DOCUMENT SQ	UAD CHECK
A	Reviewed without exception documents.	. Proceed with fabrica	ation. Issue final drawings/
B		nt will not be released,	ed with fabrication and resubmit , if any drawings/documents ons, are at this code.
С	Not accepted. Revise as ma Shipment will not be release per purchase order condition	ed, if any drawings/doo	awing/document for review. cuments requiring approval, as
D	Not required for review. Rec	ceived for information.	
The en	red only as to general conform gineer does not warrant or rep g/document is either accurate nd dimensions shall remain w	oresent that the inform or complete. Sole resp	ponsibility for correct design,
SDR	CODE EQUIPMENT TAG	REVIEWED BY	DATE
DEC	>Z PK4-6000	DLemos	2012-04-30

PROJECT NAME: Murphy Oil Cadotte 1780-005

VENDOR NAME: Canadian Water Technologies

DOCUMENT

NUMBER: 4488-ELC-0011-2

VENDOR


REVISION: A

DOCUMENT

DESCRIPTION: Building Emergency Lighting Layout

VENDOR TRANSMITTAL

NUMBER: 120418Trans05

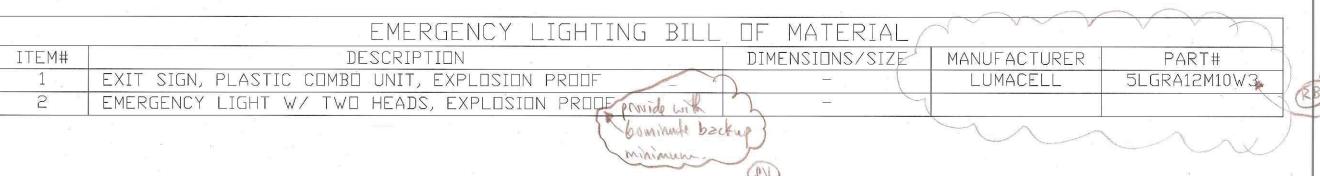


Complete B.O.M.

B)

not a classified fixture.

NDTES:

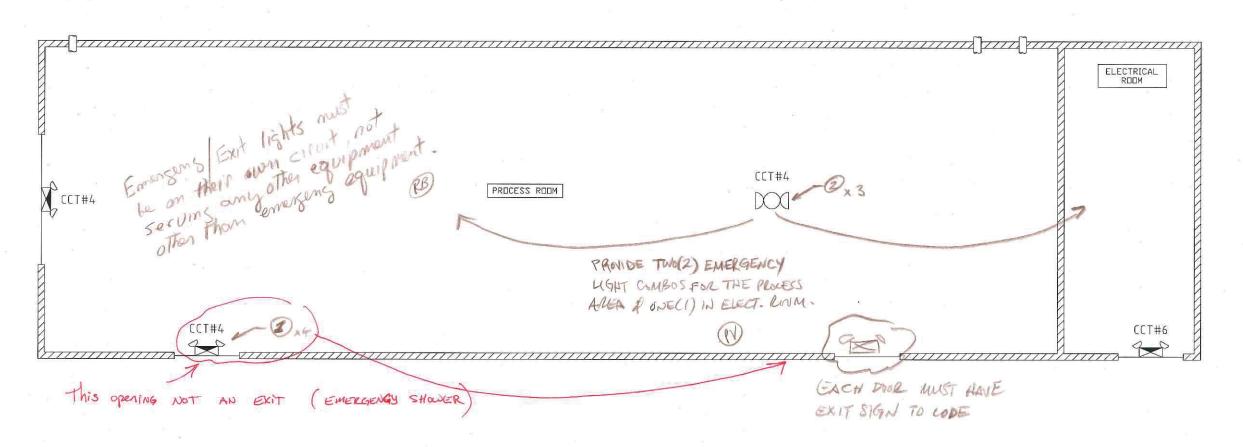

LEGEND.

1 ITEM NUMBER

_			
A	27/03/12	ISSUED FOR APPROVAL	P
REV	DATE	DESCRIPTION	1

APPROVED

NAME DATE

TRTQUEST SERVICES LTD == ELECTRICAL CONTRACTING - AUTOMATION & CONTROLS

> BAY 11 3716 56AVE S.E. CALGARY, AB T2C-2B5

SCALE	STM	
DESIGNED	PZC	
DRAWN	PZC	
CHECKED	LT	
DATE	MARCH, 2012	
PROJECT		

MURPHY OIL CADOTTE CSS PILOT WTP

DRAWING TITLE

BUILDING

EMERGENCY LIGHTING
LAYOUT

DRAWING GROUP B	SHEET	5	DF	6	REV
DRAWING NUMBER			DWG	SIZE	A
4488-FLC-0011			11:	<17	

ALL DWG'S MUST HAVE DIMENSIONS IN MM \$ APPLIED TO DWG & DWG TO BE TO SCALE.



	[ā]	VIST	A Projects Limited			
		VENDOR DRAWIN	NG/DOCUMENT SQ	UAD CHECK		
A	Reviewed without exception. Proceed with fabrication. Issue final drawings/documents.					
B	Reviewed except as marked and/or noted. Proceed with fabrication and resubmit drawing/document. Shipment will not be released, if any drawings/documents requiring approval, as per purchase order conditions, are at this code.					
С	Not accepted. Revise as marked and resubmit drawing/document for review. Shipment will not be released, if any drawings/documents requiring approval, as per purchase order conditions, are at this code.					
D	Not red	quired for review. Rece	ived for information.	9		
The en drawing	gineer do g/docume	pes not warrant or repre- ent is either accurate or	esent that the inform complete. Sole resp	ncept and specifications provided. ation contained on this ponsibility for correct design, g the drawing/document.		
SDR	DR CODE EQUIPMENT TAG REVIEWED BY DATE					
DE	02	PKG-6000	DLemon	2012-04-30		

PROJECT NAME: Murphy Oil Cadotte 1780-005

VENDOR NAME: Canadian Water Technologies

DOCUMENT

NUMBER:

4488-ELC-0012-3

VENDOR

REVISION:

A

DOCUMENT

DESCRIPTION:

Building Fan and Heater Layout

VENDOR

TRANSMITTAL

NUMBER:

PROCESS ROOM PROVIDE FOR \$ HEATER LOCATIONS & BOM of ALL DWGIS MUST HAVE DIMENSIONS IN min of PROPERLY SAMON DUS & DUG TO BE TO STALES

A 27/03/12 ISSUED FOR APPROVAL PZ
REV DATE DESCRIPTION B

APPROVED REVISIONS

NOTES

TR TQUEST

SERVICES LTD4

BAY 11 3716 56AVE S.E. CALGARY, AB T2C-2B5

SCALE NTS
DESIGNED PZC
DRAWN PZC
CHECKED LT
DATE MARCH, 2012
PROJECT

MURPHY OIL CADOTTE CSS PILOT WTP

DRAWING TITLE

BUILDING FAN AND HEATER LAYOUT

 DRAVING GROUP
 B
 SHEET
 3 0F
 6
 REV

 DRAVING NUMBER
 DWG SIZE
 A

 4488-ELC-0012
 11×17



	10-12-11-1103-1-1-1-1	VIST	ΓA Projects Limited			
		VENDOR DRAWI	NG/DOCUMENT SC	QUAD CHECK		
Α	Reviewed without exception. Proceed with fabrication. Issue final drawings/documents.					
B	Reviewed except as marked and/or noted. Proceed with fabrication and resubmit drawing/document. Shipment will not be released, if any drawings/documents requiring approval, as per purchase order conditions, are at this code.					
С	Not accepted. Revise as marked and resubmit drawing/document for review. Shipment will not be released, if any drawings/documents requiring approval, as per purchase order conditions, are at this code.					
D	Not require	ed for review. Rece	eived for information.			
The er	ngineer does g/document i	not warrant or repr s either accurate o	esent that the inform r complete. Sole res	ncept and specifications provided. nation contained on this ponsibility for correct design, ng the drawing/document.		
SDR	CODE E	QUIPMENT TAG	REVIEWED BY	DATE		
DEO	2 -	P169-6000	D. Lemon	2012-04-30		

PROJECT NAME: Murphy Oil Cadotte 1780-005

VENDOR NAME: Canadian Water Technologies

DOCUMENT

NUMBER:

4488-ELC-0013-4

VENDOR

REVISION:

A

DOCUMENT

DESCRIPTION:

Building Panel Location Layout

VENDOR TRANSMITTAL

NUMBER:

LIGHTING PANEL BILL OF MATERIAL					
ITEM#,	DESCRIPTION	DIMENSIONS/SIZE	MANUFACTURER	PART#	
1	PANELBOARD INTERIOR 30CCT	-	SQUARE D	SQD NQ430L1	
	TUB		SQUARE D	SCHW MDS	
	GROUND BAR KIT	ar and a second an	SQUARE D	SQD PK18GTA	
1 🕮 31	PANELBOARD COVER/TRIM	ē	SQUARE D	SØD NC352	
1	100A BOLT ON BREAKER		SQUARE D	SQD Q□B3100	
	40A 3 POLE BOLT ON BREAKER	=	SQUARE D	SQD Q□B340	
x - 9	20A 3 POLE BOLT ON BREAKER	- 1	SQUARE D	SQD Q□B320	
9 , 10	15A 3 POLE BOLT ON BREAKER	P=4	SQUARE D	SQD QDB315	
9 V 0	15A 1 POLE BOLT ON BREAKER		SQUARE D	SQD QOB115	
19—4	15A 1 POLE GFI BOLT ON BREAKER	XI 1938	SQUARE D	SQD QOB115GFI	
s=	15A 1 POLE EPD BOLT ON BREAKER	75 Y-20	SQUARE D	SQD QDB115EPD	

PROCESS ROOM

VENOSE TO COMPLETE

L CONDUITS SETWEEN PLUCESS AJON & ELECT. ROOM ARE RUNTED

> PROVIDE THREE CONDUIT SLEEVES

THEORY WALL FOR
CUSTOMER @ 1625 mm A.F.F.
51-3" sleeve of bushings
U1=0" sleeve of bushings

PRIVIDE BOM, DIMENSIONS, ETC OF STHEL EQUIPMENT SHOWN UN DWG.

BETWEEN ELECT. ROOM & PROCESS ROOM
(SE. YNDERFLOOD ABOVE CEILING WAY)

ELECTRICAL ROOM INDICATE WHAT THESE ARE ON BOM WITH (DIMENSIONS-PROVIDE ANDLOG & DISCRETE JE AS PELPS. FUSIBLE DISCONNECT SOLENDID VALVE BANK

BAY 11 3716 56AVE S.E. CALGARY, AB T2C-2B5

DESIGNED CHECKED MARCH, 2012

TRTQUEST SERVICES LTD4

> MURPHY OIL CADOTTE CSS PILOT WTP

DRAWING TITLE

Ut Wast Tok

BUILDING PANEL LOCATION LAYOUT

DRAWING GROUP B	SHEET 4 OF 6	REV
DRAWING NUMBER	DWG SIZE	Α
4488-ELC-0013	11×17	

ALL DWGIS MUST HAVE DIMENSION IN min & PROPERLY SHOWN ON DWG & DWG TO BE TO SCALE



			A Projects Limited NG/DOCUMENT SQ	UAD CHECK			
A	Reviewed without exception. Proceed with fabrication. Issue final drawings/documents.						
В	Reviewed except as marked and/or noted. Proceed with fabrication and resubmit drawing/document. Shipment will not be released, if any drawings/documents requiring approval, as per purchase order conditions, are at this code.						
С	Not accepted. Revise as marked and resubmit drawing/document for review. Shipment will not be released, if any drawings/documents requiring approval, as per purchase order conditions, are at this code.						
D	Not red	quired for review. Rece	ived for information.				
The eng	gineer do /docume	pes not warrant or represent is either accurate or	esent that the informatic	ncept and specifications provided. ation contained on this consibility for correct design, g the drawing/document.			
SDR CODE EQUIPMENT TAG REVIEWED BY DATE				DATE			
DEC	2	PKG-6000	Hemon	2012-04-30			

PROJECT NAME: Murphy Oil Cadotte 1780-005

VENDOR NAME: Canadian Water Technologies

DOCUMENT

NUMBER:

4488-ELC-0014-5

VENDOR

REVISION:

A

DOCUMENT


DESCRIPTION:

Building Instrumentation Layout

VENDOR

TRANSMITTAL

NUMBER:

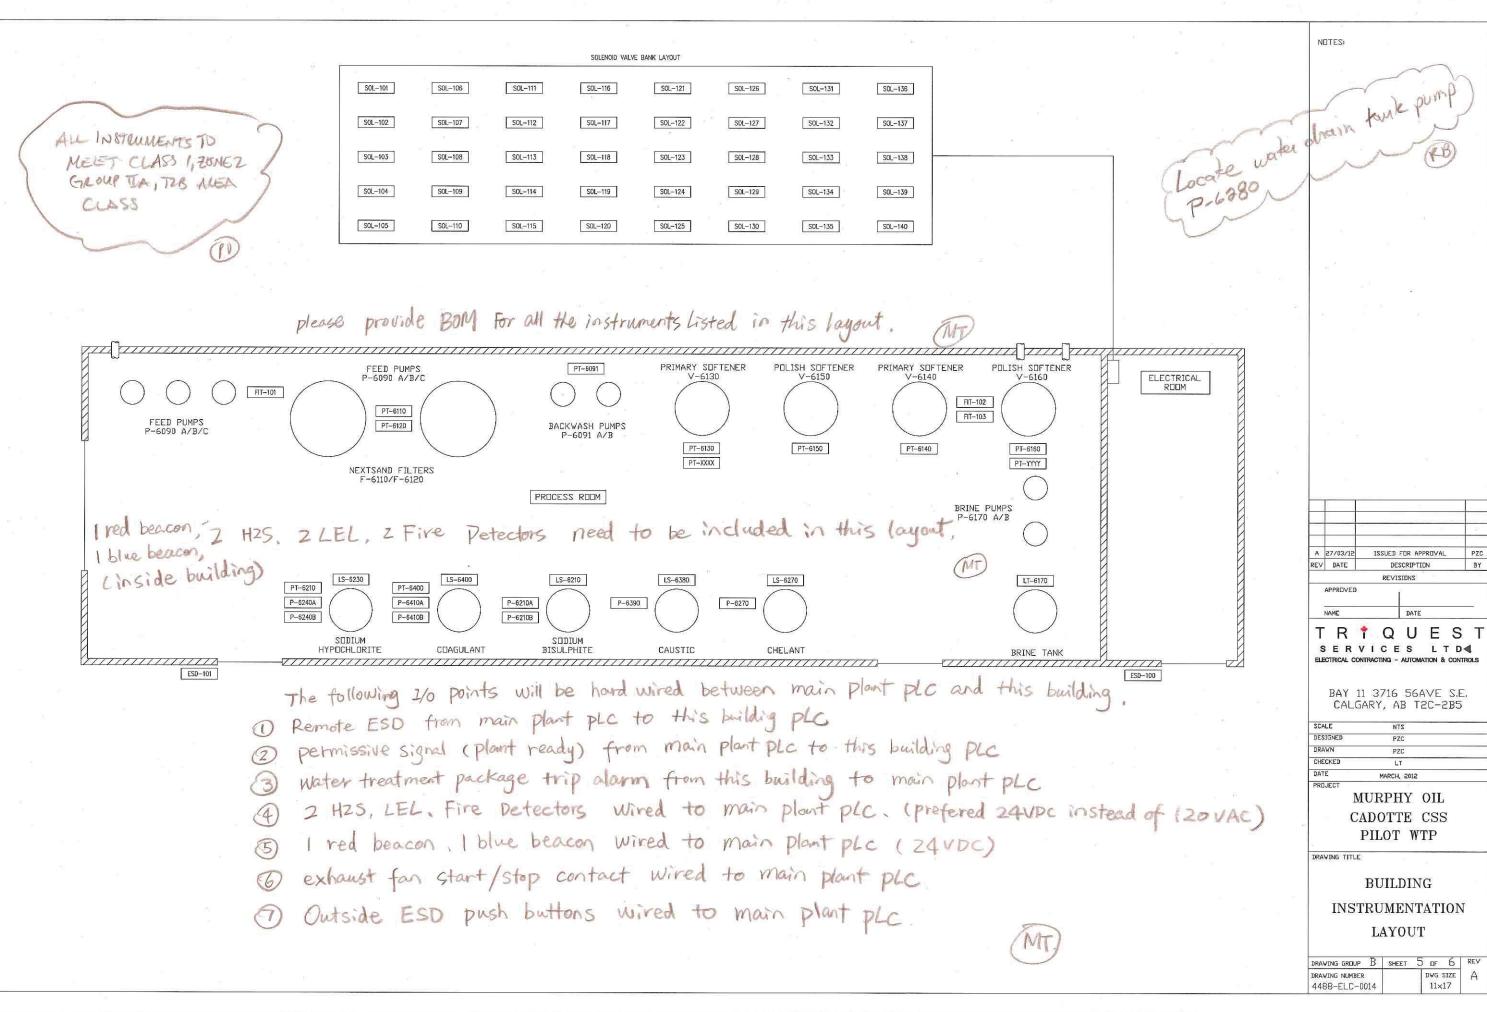

DWG SIZE

11×17



	417000000000000000000000000000000000000		A Projects Limited	iira olizaii		
			NG/DOCUMENT SQ			
A	Reviev docum		Proceed with fabrica	tion. Issue final drawings/		
B	Reviewed except as marked and/or noted. Proceed with fabrication and resubmit drawing/document. Shipment will not be released, if any drawings/documents requiring approval, as per purchase order conditions, are at this code.					
С	Not accepted. Revise as marked and resubmit drawing/document for review. Shipment will not be released, if any drawings/documents requiring approval, as per purchase order conditions, are at this code.					
D	Not red	quired for review. Rece	ived for information.			
The en drawing	gineer do g/docume	pes not warrant or repre ent is either accurate or	esent that the informatic complete. Sole resp	ncept and specifications provided. ation contained on this consibility for correct design, g the drawing/document.		
SDR	CODE	EQUIPMENT TAG	REVIEWED BY	DATE		
DE	09	PKq-6000	Domon	2012-04-30		

PROJECT NAME: Murphy Oil Cadotte 1780-005

VENDOR NAME: Canadian Water Technologies

DOCUMENT

NUMBER: <u>4488-ELC-0015-6</u>

VENDOR

REVISION: A

DOCUMENT

DESCRIPTION: Building Hazardous Location Layout

VENDOR TRANSMITTAL

NUMBER: 120418Trans05

		(ALL ELEC DWG'S TO BE	NOTES
	AREA CLASSIFICATION LEGEND	STAMED & SIGNED BY VENDOL }	1. SEALED WALLSTON
UNCLASSIF	IED AREA	the ENGINEER AS PERPS. }	PROVIDED TO MAINTA
CLASS 1	DIV 0		OF CLASSIFIED AND
CLASS 1	DIV 1	(ev)	MON CLASSIFIED
CLASS 1	DIV 2		
32103 1		g 22 V	(1)
	MUST BE ZONE CLASSIFICED. \$ SHOW GR IA \$ TEMP. TOB (AS METHANE GAS IS	PRESENT IN SOMECE WATER WELL)	5.5 g a 8
, mar		LEAKAGE.	
FANS	ABOUT LEAKAGE THEOLOGIA EXPAUST (1)	DEMINES! NOTE 1-	2
	AUST PANS & OTHER OPENINGS T		o a
		//////////////////////////////////////	
			= -
	!!!!!!!!!!!!!!!!!!!!!!!!!!!!!!!!!!!!!!		, · · ·
	////		
			A 27/03/12 ISSUED FOR APPROVAL P REV DATE DESCRIPTION 1
			REVISIONS APPROVED
			NAME DATE
			TRTQUES SERVICES LTD4 BLECTRICAL CONTRACTING - AUTOMATION & CONTROL
	~~~~~~~~~~~~~~~~~~~~~~~~~~~~~~~~~~~~~~		
			BAY 11 3716 56AVE S.E. CALGARY, AB T2C-2B5
			SCALE NTS DESIGNED PZC
			DRAWN PZC CHECKED LT DATE MARCH, 2012
PRIVIDE A	5		PROJECT MURPHY OIL
Fugitive e	MISSIGN & THIS DWG IS NOT PER &		CADOTTE CSS PILOT WTP
FUGITIVE EL STUDY AS PE APT \$05 AS	STATED   AREA CLASS DWG MUST )		DRAWING TITLE
IN PD.	COMPLY TO API SOS }		BUILDING
	COMPLY TO API SOS STANDARO AS A MINIMUM: (R)		HAZARDOUS LOCATION
			LAYOUT
			DRAWING GROUP B SHEET 6 OF 6 RED DRAWING NUMBER DWG SIZE 4
		The second secon	4488-ELC-0015 11×17



	VIS	TA Projects Limited	-			
	VENDOR DRAW	NG/DOCUMENT SQ	UAD CHECK			
A	Reviewed without exception. Proceed with fabrication. Issue final drawings/documents.					
<b>B</b> )	Reviewed except as marked and/or noted. Proceed with fabrication and resubmit drawing/document. Shipment will not be released, if any drawings/documents requiring approval, as per purchase order conditions, are at this code.					
С	Not accepted. Revise as marked and resubmit drawing/document for review. Shipment will not be released, if any drawings/documents requiring approval, as per purchase order conditions, are at this code.					
D	Not required for review. Rece	eived for information.				
The end	ed only as to general conformi gineer does not warrant or rep glocument is either accurate on d dimensions shall remain wit	resent that the information complete. Sole resp	consibility for correct design,			
SDR	CODE EQUIPMENT TAG	REVIEWED BY	DATE			
DE9	9 7169-6000	D. Leman	2012-04-30			

PROJECT NAME: Murphy Oil Cadotte 1780-005

VENDOR NAME: Canadian Water Technologies

**DOCUMENT** 

NUMBER: <u>4488-ELC-0050-1</u>

**VENDOR** 

REVISION: A

**DOCUMENT** 

DESCRIPTION: Load List

VENDOR TRANSMITTAL

NUMBER: 120418Trans05

Client: CWT

Project: Murphy Oil Cadotte CSS Pilot WTP

Project #: 4488



Voltage

Load

42.38 KW

31.56 kW

# TRTQUEST

SERVICES LTD.4

**Electrical Load List** 

Motor Calc P Power Calc P Calc P Tag No. Equipment Description Skid Phase % On Standby Continuous Intermitent Standby kW Factor KVA Kvar uous mittent KW KVA KVAR KW KVA KVAR KW KVA KVAR P-6090A RAW WATER FEED PUMP A - VFD 3.00 2.24 0.90 2.49 1.08 100 0 0 0.00 0.00 2.24 2.49 0.00 0.00 0.00 1.08 0.00 P-6090B RAW WATER FEED PUMP B - VFD 3.00 2.24 0.90 1.08 2.49 100 0 1 0 0.00 0.00 0.00 2.24 2.49 1.08 0.00 0.00 P-6090C RAW WATER FEED PUMP C - VFD 3.00 2.24 0.90 2.49 1.08 100 0 0 0.00 0.00 0.00 2.24 2.49 1.08 0.00 0.00 0.00 P-6091A BACKWASH PUMP A - VFD 3 7.46 0.90 10.00 8.29 3.61 100 0 0 0.00 0.00 0.00 8.29 0.00 7.46 3.61 0.00 0.00 7.46 0.90 P-6091B BACKWASH PUMP B - VFD 10.00 8.29 3.61 100 0 0.00 0.00 0.00 7.46 0.00 0 8.29 3.61 0.00 0.00 P-6170A BRINE TANK PUMP A - VFD 0.50 0.37 0.90 0.41 0.18 100 1 0 0 0.37 0.41 0.18 0.00 0.00 0.00 0.00 0.00 0.00 P-6170B BRINE TANK PUMP B - VFD 3 0.50 0.37 0.90 0.41 0.18 100 0 0 0.41 0.18 0.00 0.00 0.37 0.00 0.00 0.00 0.00 HTR-A BUILDING HEATER A 3 10.00 0.90 4.84 11.11 100 1 0 0 11.11 4.84 0.00 0.00 10.00 0.00 0.00 0.00 0.00 HTR-B BUILDING HEATER B 3 10.00 0.90 11.11 4.84 100 1 0 0 10.00 11.11 4.84 0.00 0.00 0.00 0.00 0.00 0.00 0.00 0.90 0.00 0.00 100 0 0 0.00 0.00 0.00 0.00 0.00 0.00 0.00 0.00 0.00 0.00 0.90 0.00 100 0.00 1 0 0 0.00 0.00 0.00 0.00 0.00 0.00 0.00 0.00 0.00 0.00 0.90 0.00 0.00 100 0 0 0.00 0.00 0.00 0.00 0.00 0.00 0.00 0.00 0.00 0.00 0.90 0.00 0.00 100 0 0 0.00 0.00 0.00 0.00 0.00 0.00 0.00 0.00 0.00 0.00 0.90 0.00 0.00 100 0 0.00 0.00 0.00 0.00 0.00 1 0 0.00 0.00 0.00 0.00 0.00 0.90 0:00 0.00 100 0 0 0.00 0.00 0.00 0.00 0.00 0.00 0.00 0.00 0.00 0.00 0.90 0.00 0.00 100 0 0.00 0 0.00 0.00 0.00 0.00 0.00 0.00 0.00 0.00 Total 20.75 23.05 10.05 21.63 10.48 0.00 0.00 24.04 0.00

CONNECTED LOAD Total Estimated Load (C+.5*I)

**Amperage** Load 47.09 kVA 56.64

35.07 kVA

42.18

VALUES TO BE CALCULATED WITH FUNDAMENTAL PUNCHES.

-			46-
	0		
A	27/03/12	ISSUED FOR APPROVAL	PZC
REV	DATE	DESCRIPTION	BY
INC.	Direct	DESCRIB TIEN	. H.

REVISIONS APPROVED

TRTQUEST SERVICES LTD4

BAY 11 3716 56AVE S.E. CALGARY, AB T2C-2B5

SCALE	NTS	
DESIGNED	PZC	
DRAWN	PZC	
CHECKED	LT	
DATE	MARCH, 2012	
DDD IECT		

MURPHY OIL CADOTTE CSS PILOT WTP

DRAWING TITLE

LOAD

LIST

AWING GROUP C	SHEET	1	DF	8	REV
AWING NUMBER			D∀G	SIZE	A
488-ELC-0050			11>	<17	



		VIS	TA Projects Limite	ed			
		<b>VENDOR DRAW!</b>	ING/DOCUMENT S	SQUAD CHECK			
A	Reviewed without exception. Proceed with fabrication. Issue final drawings/documents.						
В	Reviewed except as marked and/or noted. Proceed with fabrication and resubmit drawing/document. Shipment will not be released, if any drawings/documents requiring approval, as per purchase order conditions, are at this code.						
С	Not accepted. Revise as marked and resubmit drawing/document for review. Shipment will not be released, if any drawings/documents requiring approval, as per purchase order conditions, are at this code.						
D	Not requ	uired for review. Rece	eived for informatio	n.			
The eng	gineer doe /documer	es not warrant or repr nt is either accurate o	resent that the infor or complete. Sole re	concept and specifications provided.  mation contained on this esponsibility for correct design, ing the drawing/document.			
	SDR CODE   EQUIPMENT TAG   REVIEWED BY   DATE						
DEC	06	PKG -6600	Denon	26/2-04-36			

PROJECT NAME: Murphy Oil Cadotte 1780-005

VENDOR NAME: Canadian Water Technologies

**DOCUMENT** 

NUMBER:

4488-ELC-0060-2

VENDOR

**REVISION:** 

 $\underline{\mathbf{A}}$ 

**DOCUMENT** 

DESCRIPTION:

Cable Schedule

VENDOR

TRANSMITTAL

NUMBER:

MURPHY OIL CADOTTE CSS PILOT WTP Project Description CONDUITAND CABLE DESIGNATION CONDUITTYPES CABLE TYPES Project No. MF - MAIN FEEDER AL-ALUMINUM C-CONTROL RW90 PC - POWER / CONTROL MC - MOTOR CONTROL TRAY - CABLE TRAY NMD90 Revision Date By P - POWER F-FIRE DETECTION FX - FLEXIBLE TECK90 2-Apr-12 PZC 1 LTG - LIGHTING EMT - ELECT METALLIC TUBING TW, TEW 2 TEL-TELEPHONE PVC - PVC CONDUIT 3 CIRCUIT CONDUCTORS CABLE CONDUIT CABLE NUMBERS FROM VIA TO COMMENTS LENGTH TYPE SIZE / TYPE LOAD VOLTS No. SIZE INSUL. INSUL VOLTS SPARE MAIN BUILDING MF-480V-DIS 480 MAIN POWER DISTRIBUTION BLOCK TBA . TBA MF-DIS-XFMR 480 POWER DISTRIBUTION BLOCK TRAY XFMR-1 TECK 90 4 #8 0 MF-XFMR-LPA 208 XFMR-1 TRAY LOADCENTER PANEL TECK 90 4 #1 0 MF-LPA-CP 120 LOADCENTER PANEL TRAY CONTROL PANEL TECK 90 3 #10 0 MF-JB-480-1 480 MCC EMT 480VACJUNCTION BOX 2" EMT 15 #6 0 MF-JB-480-2 480 MCC EMT 480VAC JUNCTION BOX 2" EMT 15 #5 3 MF-JB-120-CP-1 120 LOADCENTER PANEL EMT 120VACJUNCTION BOX 11/2" EMT 20 #10 0 MF-JB-120-CP-2 120 LOADCENTER PANEL EMT 120VACJUNCTION BOX 1" EMT 10 #10 8 MF-JB-120-120 120 CONTROL PANEL EMT 11/2"EMT 120VACJUNCTION BOX 20 #12 6 MF-JB-CNTL-DI CONTROL PANEL EMT 24VDC/CONTROL JUNCTION BOX 1" EMT 20 #14 6 MF-JB-CNTL-DO CONTROL PANEL EMT 24VDC/CONTROL JUNCTION BOX 1" EMT 20 #14 4 MF-JB-CNTL-AI CONTROL PANEL EMT 24VDC/CONTROL JUNCTION BOX 2" EMT 15PAIR #18 0 MC-P-6090A 480 480VAC JUNCTION BOX TRAY RAW WATER FEED PUMP A TECK 90 3 #12 0 MC-P-6090B 480 480VAC JUNCTION BOX TRAY RAW WATER FEED PUMP B TECK 90 #12 3 0 MC-P-6090C 480 480VAC JUNCTION BOX TRAY RAW WATER FEED PUMP C TECK 90 3 #12 0 MC-P-6091A 480 480 VAC JUNCTION BOX TRAY BACKWASH PUMP A TECK 90 3 #12 0 MC-P-6091B 480 480VAC JUNCTION BOX TRAY BACKWASH PUMP B TECK 90 #12 3 0 MC-P-6170A 480 480 VAC JUNCTION BOX TRAY BRINETANK PUMP A TECK 90 #12 3 0 MC-P-6170B 480 480 VAC JUNCTION BOX TRAY BRINETANK PUMP B TECK 90 #12 3 0 P-HTR-A 480 480 VAC JUNCTION BOX TRAY CLASSIFIED AREA BUILDING HEATER A TECK 90 #12 3 0 P-HTR-B 480 480VAC JUNCTION BOX TRAY CLASSIFIED AREA BUILDING HEATER A TECK 90 #12 3 0 120 P-EF-A LOADCENTER PANEL TRAY CLASSIFIED AREA EXHAUST FAN A TECK 90 2 #14 0 P-INT-LIGHT-ER 120 LOADCENTER PANEL TRAY INTERIOR LIGHTS IN ELECTRICAL ROOM TECK 90 2 #14 0 P-E/E-LIGHT-ER 120 LOADCENTER PANEL TRAY EXTERIOR/EMERGENCY LIGHTS IN ELECTRICAL ROOM TECK 90 2 #14 0 P-INT-UGHT-JB 120 LOADCENTER PANEL TRAY 120VACJUNCTION BOX TECK 90 2 #14 0 P-E/E-LIGHT-JB 120 LOADCENTER PANEL TRAY 120VACJUNCTION BOX TECK 90 2 #14 0 P-INT-UGHT 120 120VAC JUNCTION BOX TRAY INTERIOR LIGHTS TECK 90 #14 0 P-E/E-LIGHT 120 120VAC JUNCTION BOX TRAY EXTERIOR/EMERGENCY LIGHTS TECK 90 2 #14 0 P-P-6210A 120 LOADCENTER PANEL TRAY SODIUM BISULPHITE CHEMICAL PUMP TECK 90 #14 0 P-P-6210B 120 LOADCENTER PANEL TRAY SODIUM BISULPHITE CHEMICAL PUMP TECK 90 #14 0 P-P-6240A 120 LOADCENTER PANEL TRAY SODIUM HYPOCHLORITE CHEMICAL PUMP TECK 90 2 #14 0 P-P-6240A 120 LOADCENTER PANEL TRAY SODIUM HYPOCHLORITE CHEMICAL PUMP TECK 90 2 #14 0 P-P-6270 120 LOADCENTER PANEL TRAY PHOSP HATE TANK CHEMICAL PUMP TECK 90 #14 0 P-P-6390 120 LOADCENTER PANEL TRAY CAUSTIC TANK CHEMICAL PUMP TECK 90 #14 0 P-P-6410A 120 LOADCENTER PANEL TRAY COASULANT DOSING SYSTEM CHEMICAL PUMP TECK 90 2 #14 0 P-P-6410A 120 LOADCENTER PANEL TRAY COASULANT DOSING SYSTEM CHEMICAL PUMP TECK 90 2 #14 0 24 VOC PNL-PLG-150 (MCC BLOG) TRAY BELLOS BEODO CONTROL PANEL XLPEKECK GOOV 150 TELLES. XLPE/TECK GOOV CATL JUNCTION BOX 25 B6000- CZ B6000- A 24 VDC - 20 on A TECK 416 ENTE JUNKTION BOX XLPE 300V 2 ACIC 6 TRI 86000 PI 480 MCC-700 (MC BLOG) TRAY FUSEABLE DISCOUNTEST

126 ENP-NEW THICKLIST CONTROL

CHECKED MARCH, 2012 PRILIFCT. MURPHY OIL CADOTTE CSS PILOT WTP (BY CUSTOMER) VENDOR TO PROVIDE 2"
PREDTHROUGHS DRAVING TITLE "CUNDUIT I vendor to provide ( BY ENSTONER) INTO MEL RUSA 25" sleeve though will (BY CUSTOMER), VENDOR TO PROVIDE INTO process room 3" CONDUIT FEEDTHERIGH INTO MIC for access to J. B. s. RUDM

NUTES

ISSUED FOR APPROVAL

DESCRIPTION

TRTQUEST

SERVICES LTD4

BAY 11 3716 56AVE S.E.

CALGARY, AB T2C-2B5

PZC

REV DATE

DRAWN

APPROVED

PZC

BY

Project Description MURPHY OIL CADOTTE CSS PILOT WTP Project No. 4488

Date By

2-Apr-12 PZC

Revision

1

2

3

CONDUIT AND CABLE DESIGNATION

MF - MAIN FEEDER C - CONTROL

PC - POWER / CONTROL

MC - MOTOR CONTROL

F - FIRE DETECTION

CONDUIT TYPES CABLE TYPES
AL - ALUMINUM RW90
TRAY - CABLE TRAY NMD90
FX - FLEXIBLE TECK90
EMT - ELECT METALLIC TUBING TW, TEW

LTG - LIGHTING TEL - TELEPHONE D - DATA

PVC - PVC CONDUIT

CABLE NUMBERS	CIF	RCUIT				CABLE	CONDUIT			CONDUCT	DRS					
BLE NUMBERS	LOAD	VOLTS	FROM	VIA	то	TYPE	SIZE/TYPE	No.	SIZE	INSUL.	INSUL.	VOLTS	SPARE	LENGTH (IN MT)	COMMENTS	
						MAIN	BUILDING					•	•			
P-ESD-100		120	120VAC JUNCTION BOX	TRAY	CONTROL PANEL ESD	TECK 90		2	#14				0			
P-ESD-101		120	120VAC JUNCTION BOX	TRAY	PROCESS ROOM ESD	TECK 90		2	#14				0			
P-G5-100		120	120VAC JUNCTION BOX	TRAY	LEL DETECTOR	TECK 90		2	#14				0			
P-GS-101		120	120VAC JUNCTION BOX	TRAY	H2S DETECTOR	TECK 90		2	#14				0			
P-FD-100		120	120VAC JUNCTION BOX	TRAY	FIRE DETECTOR	TECK 90		2	#14				0			
P-SD-100		120	120VAC JUNCTION BOX	TRAY	ELECTRICAL ROOM SMOKE DETECTOR	TECK 90		2	#14				0			]
P-FIT-101		120	120VAC JUNCTION BOX	TRAY	FLOW TRANSMITTER	TECK 90		2	#14				0			
P-FIT-102		120	120VAC JUNCTION BOX	TRAY	FLOW TRANSMITTER	TECK 90		2	#14				0			~~j
P-FIT-103		120	120VAC JUNCTION BOX	TRAY	FLOW TRANSMITTER	TECK 90		2	#14				0			
C-LS-6210	+		24VDC/CONTROL JUNCTION BOX	TRAY	SODIUM BISULPHITE TANK LEVEL SWITCH	TECK 90		2	#14				0			-
C-LS-6230			24VDC/CONTROL JUNCTION BOX	TRAY	SODIUM HYPOCHLORITE TANK LEVEL SWITCH	TECK 90		2	#14				0			
C-LS-6270			24VDC/CONTROL JUNCTION BOX	TRAY	PHOSPHATE TANK LEVEL SWITCH	TECK 90		2	#14				0	<b> </b>		
C-LS-6380			24VDC/CONTROL JUNCTION BOX	TRAY	CAUSTIC TANK LEVELS WITCH	TECK 90	†·····	2	#14				0			
C-LS-6400			24VDC/CONTROL JUNCTION BOX	TRAY	COASULANT DOSING SYSTEM TANK LEVEL SWITCH	TECK 90	-	2	#14				0			_
C-FD-100			24VDC/CONTROL JUNCTION BOX	TRAY	FIRE DETECTOR	TECK 90		2	#14				0			
C-SD-100			24VDC/CONTROL JUNCTION BOX	TRAY	ELECTRICAL ROOM SMOKE DETECTOR	TECK 90		2	#14				0			
I-P-6210A			24VDC/CONTROL JUNCTION BOX	TRAY	SODIUM BISULPHITE CHEMICAL PUMP	TECK 90		2	#14				0			
C-P-6210A			24VDC/CONTROL JUNCTION BOX	TRAY		TECK 90	l	2	#14				0			
C-P-6240A			24VDC/CONTROL JUNCTION BOX	TRAY	SODIUM BISULPHITE CHEMICAL PUMP SODIUM HYPOCHLORITE CHEMICAL PUMP	TECK 90	•	2	#14				0			
C-P-6240A			24VDC/CONTROL JUNCTION BOX	TRAY	SODIUM HYPOCHLORITE CHEMICAL PUMP	TECK 90	l	2	#14				0			
C-P-6270		<del> </del>	24VDC/CONTROL JUNCTION BOX	TRAY	PHOSPHATE TANK CHEMICAL PUMP	TECK 90	1	2	#14				0			A 2
C-P-6390			24VDC/CONTROL JUNCTION BOX	TRAY	CAUSTIC TANK CHEMICAL PUMP	TECK 90		2	#14				0			REV
C-P-6410A			24VDC/CONTROL JUNCTION BOX	TRAY			l	2	#14				0			
C-P-6410A C-P-6410A			24VDC/CONTROL JUNCTION BOX	TRAY	COASULANT DOSING SYSTEM CHEMICAL PUMP COASULANT DOSING SYSTEM CHEMICAL PUMP	TECK 90 TECK 90	<b>†</b>	2	#14				0			AF
C-FIT-101			24/DC/CONTROL HINGTION BOY	TRAY	FLOW TRANSMITTER	TECK 90		1PAIR	#18				0			NA
			24VDC/CONTROL JUNCTION BOX		FLOW TRANSMITTER				•••••							T
C-FIT-102 C-FIT-103			24VDC/CONTROL JUNCTION BOX 24VDC/CONTROL JUNCTION BOX	TRAY TRAY	FLOW TRANSMITTER FLOW TRANSMITTER	TECK 90 TECK 90		1PAIR 1PAIR	#18 #18				0			s
E DT 6004			24/DC/CONTROL HINGTON COV	TDAY	DACKWASH DILAB SVETTE A DESCRIPT TO A VEHICLE	TECH CO		ADAID	gan.							ELEC
C-PT-6091			24VDC/CONTROL JUNCTION BOX	TRAY	BACKWASH PUMP SYSTEM PRESSURE TRANSMITTER	TECK 90		1PAIR	#18			<del> </del>	0	ļ		
C-PT-6110			24VDC/CONTROL JUNCTION BOX	TRAY	NEXTSAND FILTER PRESSURE TRANSMITTER	TECK 90	<del> </del>	1PAIR	#18				0			
C-PT-6120 C-PT-6130			24VDC/CONTROL JUNCTION BOX 24VDC/CONTROL JUNCTION BOX	TRAY	N EXTSAND FILTER PRESSURE TRANSMITTER PRIMARY SOFTENER PRESSURE TRANSMITTER	TECK 90		1PAIR 1PAIR	#18 #18			<del>-</del>	0			
		+	1 341	TRAY		TECK 90		1PAIR	#18				0			SCAL
-PT-6140 -PT-6150			24VDC/CONTROL JUNCTION BOX 24VDC/CONTROL JUNCTION BOX	TRAY	PRIMARY SOFTENER PRESSURE TRANSMITTER	TECK 90		1PAIR	#18	-		<b></b>	0			DESI DRA
			24VDC/CONTROL JUNCTION BOX		POLISH SOFTENER PRESSURE TRANSMITTER				#18			<b>.</b>	0			CHEC
-PT-6160			24VDC/CONTROL JUNCTION BOX	TRAY TRAY	PO LISH SOFTENER PRESSURE TRANSMITTER SO DIUM BIS UL PHITE PRESSURE TRANSMITTER	TECK 90 TECK 90	<b>+</b>	1PAIR 1PAIR	#18				0			DATE
C-PT-6210	1	+		CONTRACTOR CONTRACTOR			-	and the same of th		+		1	<del></del>			PROJ
-PT-6400			24VDC/CONTROL JUNCTION BOX	TRAY	COASULANT DOSING SYSTEM PRESSURE TRANSMITTER	TECK 90		1PAIR	#18			<del>-</del>	0			
-PT-XXXX			24VDC/CONTROL JUNCTION BOX	TRAY	PRIMARY SOFTENER SYSTEM PRESSURE TRANSMITTER	TECK 90	•	1PAIR	#18			-	0			
C-PT-YYYY			24VDC/CONTROL JUNCTION BOX	TRAY	POLISH SOFTENER SYSTEM PRESSURE TRANSMITTER	TECK 90		1PAIR	#18				0			{
C-LT-6170			24VDC/CONTROL JUNCTION BOX	TRAY	BRINE TANK LEVEL TRANSMITTER	TECK 90		1PAIR	#18				0			
																DRA

ISSUED FOR APPROVAL

DESCRIPTION
REVISIONS

BY

NOTES:

BAY 11 3716 56AVE S.E. CALGARY, AB T2C-2B5

SCALE NTS
DESIGNED PZC
DRAWN PZC
CHECKED LT
DATE MARCH, 2012
PROJECT

MURPHY OIL
CADOTTE CSS
PILOT WTP

CABLE

SCHEDULE

DRAWING GROUP C	SHEET C	) OF	0	NL V
DRAWING NUMBER		DWG	SIZE	Α
4488-ELC-0061		11>	<17	



		VIST	A Projects Limited								
			NG/DOCUMENT SQ								
Α	Reviewed without exception. Proceed with fabrication. Issue final drawings/ documents.										
В	Reviewed except as marked and/or noted. Proceed with fabrication and resubmit drawing/document. Shipment will not be released, if any drawings/documents requiring approval, as per purchase order conditions, are at this code.										
С	Not ac Shipm	Not accepted. Revise as marked and resubmit drawing/document for review.  Shipment will not be released, if any drawings/documents requiring approval, as per purchase order conditions, are at this code.									
D		quired for review. Rece									
The endrawing	ngineer do ng/docume	pes not warrant or repre- ent is either accurate or	esent that the inform complete. Sole resp	ncept and specifications provided ation contained on this ponsibility for correct design, g the drawing/document.							
	CODE	EQUIPMENT TAG PICG-6000		DATE -2012 - 04 - 30							

PROJECT NAME: Murphy Oil Cadotte 1780-005

VENDOR NAME: Canadian Water Technologies

**DOCUMENT** 

NUMBER:

4488-ELC-0062-4

**VENDOR** 

**REVISION:** 

 $\underline{\mathbf{A}}$ 

**DOCUMENT** 

**DESCRIPTION:** 

Cable Schedule

**VENDOR** 

TRANSMITTAL

NUMBER:

Project Description Project No.

MURPHY OIL CADOTTE CSS PILOT WTP

Revision 1

Date 2-Apr-12 PZC

2 3 4

CONDUIT AND CABLE DESIGNATION

MF - MAIN FEEDER PC - POWER / CONTROL MC - MOTOR CONTROL

P - POWER LTG - LIGHTING

TEL-TELEPHONE

D-DATA

F - FIRE DETECTION

AL-ALUMINUM TRAY - CABLETRAY FX - FLEXIBLE

CONDUITTYPES

RW90 NMD90 TECK90

**CABLE TYPES** 

EMT - ELECT METALLIC TUBING TW, TEW

PVC - PVC CONDUIT

CABLE NUMBERS	CIR	CUIT	race and	2000		CABLE	CONDUIT		68	CONDUCT						
	LOAD	VOLTS	FROM	VIA	то	TYPE	SIZE/TYPE	No.	SIZE	INSUL	INSUL	VOLTS	SPARE	LENGTH (IN MT)	COMMENTS	
						MAIN	BUILDING								EXAMENDED STREET	10 21
C-SOL-101			CONTROL PANEL	EMT	SOLENOID BANK		1" EMT	2	#14	***************************************	·	·	0			
C-SOL-102			CONTROL PANEL	EMT	SOLENOID BANK		1" EMT	2	#14			1	0			
C-SOL-103			CONTROL PANEL	EMT	SOLENOID BANK		1" EMT	2	#14				0			
C-SOL-104		ļI	CONTROL PANEL	EMT	SOLENOID BANK		1" EMT	2	#14	N 18 W			0		e-	***************************************
C-SOL-105			CONTROL PANEL	EMIT	SOLENOID BANK		1" EMT	2	#14				0			
C-SOL-106			CONTROL PANEL	EMT	SOLENOID BANK		1" EMT	2	#14				0			***************************************
C-SOL-107	ļ	<u> </u>	CONTROL PANEL	EMT	SOLENOID BANK		1" EMT	2	#14				0			***************************************
C-SOL-108			CONTROL PANEL	EMT	SOLENOID BANK		1" EMT	2	#14				0			***************************************
C-SOL-109			CONTROL PANEL	EMT	SOLENOID BANK		1" EMT	2	#14				0		9 2	
C-SOL-110			CONTROL PANEL	EMT	SOLENOID BANK		1" EMT	2	#14				0			
C-SOL-111			CONTROL PANEL	EMT	SOLENOID BANK		1" EMT	2	#14				. 0		K	
C-SOL-112			CONTROL PANEL	EMT	SOLENOID BANK		1" EMT	2	#14				0		The second secon	
C-50L-113		1	CONTROL PANEL	EMT	SOLENOID BANK		1" EMT	2	#14				0		-	
C-SOL-114			CONTROL PANEL	EMT	SOLENOID BANK		1" EMT	2	#14				0			***************************************
C-SOL-115			CONTROL PANEL	EMT	SOLENOID BANK		1" EMT	2	#14		Ì	Ì	0			
C-SOL-116			CONTROL PANEL	EMT	SOLENOID BANK		1" EMT	2	#14				0			
C-SOL-117			CONTROL PANEL	EMT	SOLENOID BANK		1" EMT	2	#14				0	• • • • • • • • • • • • • • • • • • • •		
C-SOL-118			CONTROL PANEL	EMT	SOLENOID BANK		1" EMT	2	#14				0	†·····		***************************************
C-SOL-119			CONTROL PANEL	EMT	SOLENOID BANK		1" EMT	2	#14		•		0		-	************************
C-SOL-120			CONTROL PANEL	EMT	SOLENOID BANK	T	1" EMT	2	#14				0			***************************************
C-50L-121			CONTROL PANEL	EMT	SOLENOID BANK		1" EMT	2	#14	****	1	1	0			***************************************
C-SOL-122			CONTROL PANEL	EMT	SOLENOID BANK	- 1	1" EMT	2	#14				0			
C-SOL-123			CONTROL PANEL	EMT	SOLENOID BANK		1" EMT	2	#14	***************************************	1	<u> </u>	0		-	
C-SOL-124			CONTROL PANEL	EMT	SOLENOID BANK		1" EMT	2	#14		io ti		0		<i>b</i>	***************************************
C-SOL-125	25		CONTROL PANEL	EMT	SOLENOID BANK		1" EMT	2	#14				0			
C-50L-126			CONTROL PANEL	EMT	SOLENOID BANK	E 1	1" EMT	2	#14				0			
C-SOL-127			CONTROL PANEL	EMT	SOLENOID BANK		1" EMT	2	#14				0			
C-SOL-128			CONTROL PANEL	EMT	SOLENOID BANK		1" EMT	2	#14				0			
C-SOL-129			CONTROL PANEL	EMT	SOLENOID BANK		1" EMT	2	#14				0	*		
C-SOL-130		l	CONTROL PANEL	EMT	SOLENOID BANK		1" EMT	2	#14		Î	Ì	0			*****************
C-SOL-131	ļ		CONTROL PANEL	EMT	SOLENOID BANK		1" EMT	2	#14				0			***************************************
C-SOL-132			CONTROL PANEL	EMT	SOLENOID BANK		1" EMT	2	#14		0.010-0.000-0.000		0			
C-SOL-133			CONTROL PANEL	EMT	SOLENOID BANK		1" EMT	2	#14				0			***************************************
C-SOL-134			CONTROL PANEL	EMT	SOLENOID BANK		1" EMT	2	#14			Ĭ	0		1	
C-SOL-135			CONTROL PANEL	EMT	SOLENOID BANK		1" EMT	2	#14				0			
C-SOL-136			CONTROL PANEL	EMT	SOLENOID BANK		1" EMT	2	#14			=	0			
C-SOL-137			CONTROL PANEL	EMT	SOLENOID BANK		1" EMT	2	#14				0			
C-SOL-138			CONTROL PANEL	EMT	SOLENOID BANK		1" EMT	2	#14				0	L		***************************************
C-SOL-139			CONTROL PANEL	EMT	SOLENOID BANK		1" EMT	2	#14				0			
C-SOL-140			CONTROL PANEL	EMT	SOLENOID BANK		1" EMT	- 2	#14				0			************
							. (1000 1000 1000 1			19		a "				

27/03/12 ISSUED FOR APPROVAL DESCRIPTION REVISIONS NAME TRTQUEST SERVICES LTD4

BAY 11 3716 56AVE S.E. CALGARY, AB T2C-2B5

DESIGNED PZC PZC CHECKED MARCH, 2012 PROJECT

> MURPHY OIL CADOTTE CSS PILOT WTP

DRAWING TITLE

NOTES

CABLE

SCHEDULE

	DRAWING GROUP	C	SHEET	4	OF	8	REV
ł	DRAWING NUMBER				DWG	SIZE	Α
Ì	4488-ELC-006	62			11:	<17	



			A Projects Limited								
		<b>VENDOR DRAWII</b>	NG/DOCUMENT SQ	UAD CHECK							
A	Reviewed without exception. Proceed with fabrication. Issue final drawings/documents.										
В	Reviewed except as marked and/or noted. Proceed with fabrication and resubmit drawing/document. Shipment will not be released, if any drawings/documents requiring approval, as per purchase order conditions, are at this code.										
С	Not accepted. Revise as marked and resubmit drawing/document for review. Shipment will not be released, if any drawings/documents requiring approval, as per purchase order conditions, are at this code.										
D	Not red	quired for review. Rece	ived for information.								
The er drawin	ngineer do g/docume	pes not warrant or repre ent is either accurate o	esent that the informatic complete. Sole resp	ncept and specifications provided ation contained on this consibility for correct design, g the drawing/document.							
	CODE	<b>EQUIPMENT TAG</b>	REVIEWED BY	DATE							
DE	04	PKG-6000	D. Lemon	2012-04-30							

PROJECT NAME: Murphy Oil Cadotte 1780-005

VENDOR NAME: Canadian Water Technologies

**DOCUMENT** 

NUMBER: 4488-ELC-0070-5

**VENDOR** 

REVISION: A

**DOCUMENT** 

DESCRIPTION: Panel Schedule

VENDOR TRANSMITTAL

NUMBER: <u>120418Trans05</u>

Power Source:		LP-A Location						ocation:	Murphy Oil Cadotte CSS Pilot WTP	NOTES:	
Feeder:									Wall Mounted PANEL W MCC 8409		
	Main B	reaker:	125/	4			Mo				
POWER SUPER	SMEL	Mains:	125/	4	N		77 - 74	1, 10,100			
DESCRIPTION	kW	BKR	CCT	Α	В	С	CCT	BKR	kW	DESCRIPTION	
CONTROL PANEL SHINLD BE UN WS		15A	1	*			2	15A	***************************************	EXHAUST FAN A	H
INTERIOR LIGHTS		15A	3		*	***************************************	4	15A		EXTERIOR / EMERGENCY LIGHTS	
INTERIOR LIGHTS ELECTRICAL ROOM		15A	5		16	*	6	15A		EXTEMER LIGHTS ELECTRICAL ROOM	
P-6210A CHEMICAL PUMP		15A	7	*	*		8	15A		P-6210B CHEMICAL PUMP	
P-6240A CHEMICAL PUMP		15A	9		*	on the same of the	10	15A		P-6240B CHEMICAL PUMP	PUT ON SEPACATE
P-6270 CHEMICAL PUMP		15A	11		-	*	12	15A		P-6390 CHEMICAL PUMP	ect -
P-6410A CHEMICAL PUMP		15A	13	*		-	14	15A		P-6410B CHEMICAL PUMP	/ D
SPARE	2	15A	15	a	*		16	15A		SPARE	L
SPARE		15A	17			*	18	15A		SPARE	
			19	¥			20				
			21	12	*		22	7			A 27/03/12 ISSUED FOR APPROVAL PZC REV DATE DESCRIPTION BY
			23			*	24				REVISIONS APPROVED
			25	*			26				TRTQUEST
			27		*		28				SERVICES LTD   ELECTRICAL CONTRACTING - AUTOMATION & CONTROLS
			29			*	30	1			BAY 11 3716 56AVE S.E. CALGARY, AB T2C-2B5
			31	*			32				SCALE NTS DESIGNED PZC
			33		*		34				DRAWN PZC CHECKED LT
			35			*	36				PROJECT MARCH, 2012  MURPHY OIL
			37	*	51		38				CADOTTE CSS PILOT WTP
	-		39		*		40		***************************************		DRAVING TITLE
		•••••••••••••••••••••••••••••••••••••••	41	t e		*	42	***************************************	***************************************		PANEL SCHEDULE
							-		*		SCHEDOLE
											DRAWING GROUP C SHEET 5 OF 8 REV DRAWING NUMBER DWG SIZE A
					11	2				2 g # A	4488-ELC-0070 11×17