P&ID's

PROJECT DESCRIPTION

ONE (1) DRU OFF-GAS COMPRESSOR PACKAGE

FOR: MEG ENERGY

LOCATION NAME: HI-Q FIELD DEMO PILOT, BRUDERHEIM, AB

LSD: SE 1/4-34-055-20 W4M

FABRICATED BY:

ENERFLEX LTD.

CALGARY, ALBERTA, CANADA

TANK CAPACITIES

GLYCOL (CLOW) EXPANSION TANK: 20 US GALLONS GLYCOL STORAGE TANK: 260 US GALLONS WASTE OIL STORAGE TANK: 260 US GALLONS

POWER REQUIREMENTS

COMPRESSOR MOTOR (5KM-1401) VOL: 4000 VAC/3PH/60HZ 700 HP SUCTION FILTER DRAIN PUMP MOTOR (5PM-1101) VOL: 575 VAC/3PH/60HZ 1.5 HP BUILDING HEATER (5BH-2101 A/B) VOL: 575 VAC/3PH/60HZ 10 KW BUILDING FAN MOTOR (5BFM-2104) VOL: 120 VAC/1PH/60HZ 0.25 HP GLYCOL CIRCULATION PUMP MOTOR (5PM-6101) VOL: 575 VAC/3PH/60HZ 5 HP COOLER MOTOR (5EM-2101) VOL: 575VAC/3PH/60HZ 25 HP VOL: 575 VAC/3PH/60HZ 3KW IMMERSION HEATER (5HTR-1201) CONTROL PANEL: VOL: 120 VAC AMPS: NOM: 5 FIRE DETECTION: VOL: 24 VDC AMPS: NOM: 5 GAS DETECTION: VOL: 24 VDC AMPS: NOM: 5 INT. LIGHTS: VOL: 347 VAC AMPS: NOM: 1.7 EXT. LIGHTS: VOL: 347 VAC AMPS: NOM: 0.8 RECEPTACLES: VOL: 120 VAC AMPS: NOM: 30

SYSTEM CONSUMABLES

COMPRESSOR LUBE OIL: EFX S5-150, 135 US GALLONS

50% ETHYLENE INHIBITED GLYCOL/WATER SOLUTION, 46 US GALLONS GLYCOL:

DESIGN CRITERIA & APPLICABLE CODES

SITE ELEVATION:

BAROMETRIC PRESSURE: AMBIENT TEMPERATURE: 90°F MAXIMUM

PROCESS INLET: DESIGN 230 PSIG @ 300°F PROCESS FINAL DISCHARGE: DESIGN 230 PSIG @ 300°F MINIMUM PRESSURE 90 PSIG INSTRUMENT AIR:

MAXIMUM PRESSURE 150 PSIG

QUALITY FILTERED/DRY, 50°F MAXIMUM DEW POINT

APPLICABLE CODE: CODE PIPING B31.3 - 2012

> NON-CODE PIPING EFX C01. 1mm (0.039") CA ASME SECTION VIII, DIV 1 VESSEL EXCHANGER ASME SECTION VIII, DIV 1

STRUCTURAL CWB ELECTRICAL CEC 2012

REGISTRATION: VESSEL AΒ

MISCELLANEOUS: GASKETS CG TYPE, SPIRAL WOUND, GRAPHITE FILLED, 316SS

BOLTING STUDS - SA-193-B7, NUTS - SA-194-2H PROCESS PIPE CARBON STEEL

UTILITY PIPE CARBON STEEL

RAISED FACE (UNLESS OTHERWISE NOTED) FLANGES

ELECTRICAL: RIGID ALUMINUM CONDUIT

SUITABLE FOR USE IN: CLASS I, DIV. 2, GROUP D & CLASS I, ZONE 2, GROUP IIA

DESIGN SPECIFICATION:

ENERFLEX LTD. (EFX) SCOPE OF SUPPLY ON THIS PROJECT CONSISTS OF ONE SCREW SKIDDED GAS COMPRESSOR PACKAGE.

PACKAGE CONSISTS OF ONE (1) TECO 700HP EMD DRIVING A FRICK SGC-2821, ONE STAGE, DRU OFF-GAS COMPRESSOR.

PRIMER (VESSELS, PIPING, -FIN-1A, CLOVERDALE 703 SERIES, ECOPRIME WATER-BASED

STRUCTURAL) PRIMER, GREY

PAINT (VESSELS, PIPING, -FIN-1A, CLOVERDALE 703 SERIES, ECOLOGIC WATER-BASED

INDUSTRIAL ENAMEL, F-34 WARM GREY STRUCTURAL)

PROCESS PIPING (SWEET): -10% RADIOGRAPHIC TESTING

-1/16" CORROSION ALLOWANCE -NO PWHT

-SSPC-SP3 -NO PICKLING

FLARE HEADER PIPING (SOUR): -100% RADIOGRAPHIC TESTING

-1/8" CORROSION ALLOWANCE

-PWHT -SSPC SP3 -NO PICKLING

VESSELS: -5% RADIOGRAPHIC TESTING - RT2

-UT ON ALL CAT. 'D' WELDS -1/16" CORROSION ALLOWANCE

-NO PWHT -SSPC-SP3 -NO PICKLING

2 AS BUILT 1 ISSUED FOR CONSTRUCTION JAN 13/15 TR NR 0 ISSUED FOR CONSTRUCTION NOV 27/14 SJ NR B ISSUED FOR APPROVAL OCT 09/14 TW NR CUST PO A ISSUED FOR APPROVAL JUL 14/14 SJ NR APEGA PERMIT No:

^{NTE} FEB 13/14 NTS DRAWN BY CHECKED BY APPROVED BY A.TRAN N.REZAEYAN B.LANGER
PROJECT MANAGER PROJECT ENGINEER
B.LANGER N.REZAEYAN

P8651

OPER. 490 511 591

MEG ENERGY 1500 BPD H1-Q FD PILOT DRU OFF-GAS COMPRESSOR 5K-1401

WORK E001123-01

ENERFLEX Calgary, Alberta, Canada

P & I DIAGRAM PROJECT DESCRIPTION & OVERVIEW

E001123-01-099



INSTRUMENT AIR: 300 SCFD 3000 FT ABOVE MEAN SEA LEVEL 13.2 PSIA MINIMUM -20°F

TUBING SPECIFICATIONS

	PROCESS TUBING				
TUBING SPECIFICATION	ENERFLEX: G-S04-CSZ-CS-S16-375				
TUBING MATERIAL	304SS				
FITTING MATERIAL	ZINC PLATED CARBON STEEL C/W SS BACK FERRULE				
OUTSIDE DIAMETER	MINIMUM WALL THICKNESS				
1/4"	0.035"				
3/8"	0.035"				
1/2"	0.049"				
	-				
-	•				

	UTILITY TUBING					
TUBING SPECIFICATION	ENERFLEX: G-S04-CSZ-CS-S16-375					
TUBING MATERIAL	304SS					
FITTING MATERIAL	ZINC PLATED CARBON STEEL C/W SS BACK FERRULE					
OUTSIDE DIAMETER	MINIMUM WALL THICKNESS					
1/4"	0.035"					
3/8"	0.035"					
1/2"	0.049"					
3/4"	0.065"					
1"	0.083"					

SMALL BORE NPT & SW PIPING & FITTINGS

PROCESS & SCREW PIPING SPECIFICATIONS


	SWEET SERVICE (-20-650°F,1/16"CA)											
EFX PIPE SPECIFICATION -			PIP	ING	FITTINGS							
		NPT		SW		NPT & THREADOLET	SW & SOCKOLET					
C11	150#	1/2"	160	1/2"-1 1/2"	XS	1/2" 2	, 2000#					
CII	130#	3/4"-2"	XS	2"	STD	1/2 -2	1/2"-2" 3000#					
				•								


UTILITY PIPING SPECIFICATIONS


	SMALL BORE NPT & SW PIPING & FITTINGS LOW PRESSURE UTILITY SERVICE											
EFX PIPE SPECIFICATION		PIP	ING	FITTINGS								
EFX PIPE SPECIFICATION	NPT		SW		NPT & THREADOLET	SW & SOCKOLET						
CO1 NON-CODE	1/2"-3/4"	160	1/2"-1 1/2"	XS	1/2"-2" 3000#	1/2"-2" 3000#						
COT NON-CODE	1"-2"	XS	2"	STD	1/2 -2 3000#	1/2 -2 3000#						





					DATE FEB 12/14 SCALE NTS	MEG ENERGY		D
2	2 AS BUILT I	MAY 05/15	SJ	NID	DRAWN BY CHECKED BY APPROVED BY	1	ENERFLEX	P & I DIAGRAM
1	1 ISSUED FOR CONSTRUCTION	JAN 13/15	TR	NR	A.TRAN N.REZAEYAN B.LANGER	1500 BPD HI-Q FD PILOT	Calgary, Alberta,	PROJECT DESCRIPTION
0	ISSUED FOR CONSTRUCTION	NOV 27/14	SJ	NR	PROJECT MANAGER PROJECT ENGINEER B.LANGER N.REZAEYAN	DRU OFF-GAS COMPRESSOR		& OVERVIEW
В	B ISSUED FOR APPROVAL	OCT 09/14	TW	NR	CUST PO _	5K-1401	Canada	a overview
A	A ISSUED FOR APPROVAL	JUL 14/14	SJ	NR	APEGA PERMIT No: DRCE1 OPER 400 E1		DWG E001123-01-0	OO SHT O REV O
RE'	V DESCRIPTION	DATE	BY	APR	APEGA PERMIT No: P8651 OPER. 490 51	1 591 WORK E001123-01	NO EUUTIZJ-UT-U	99 2 2

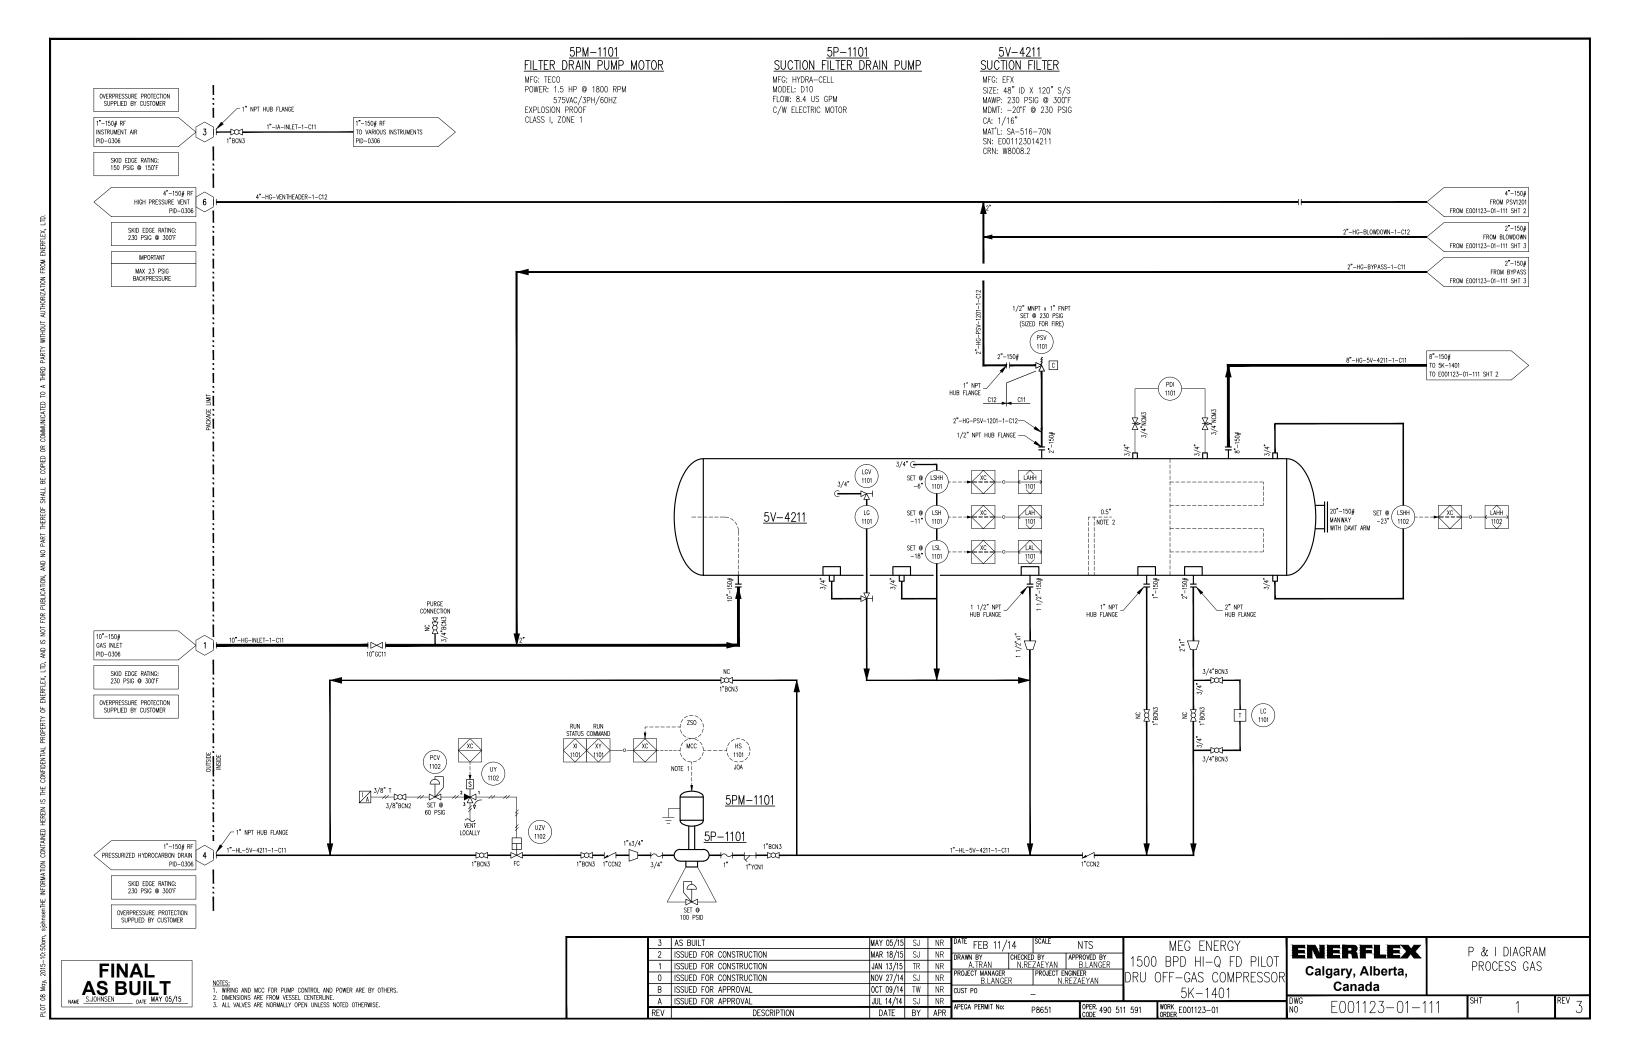

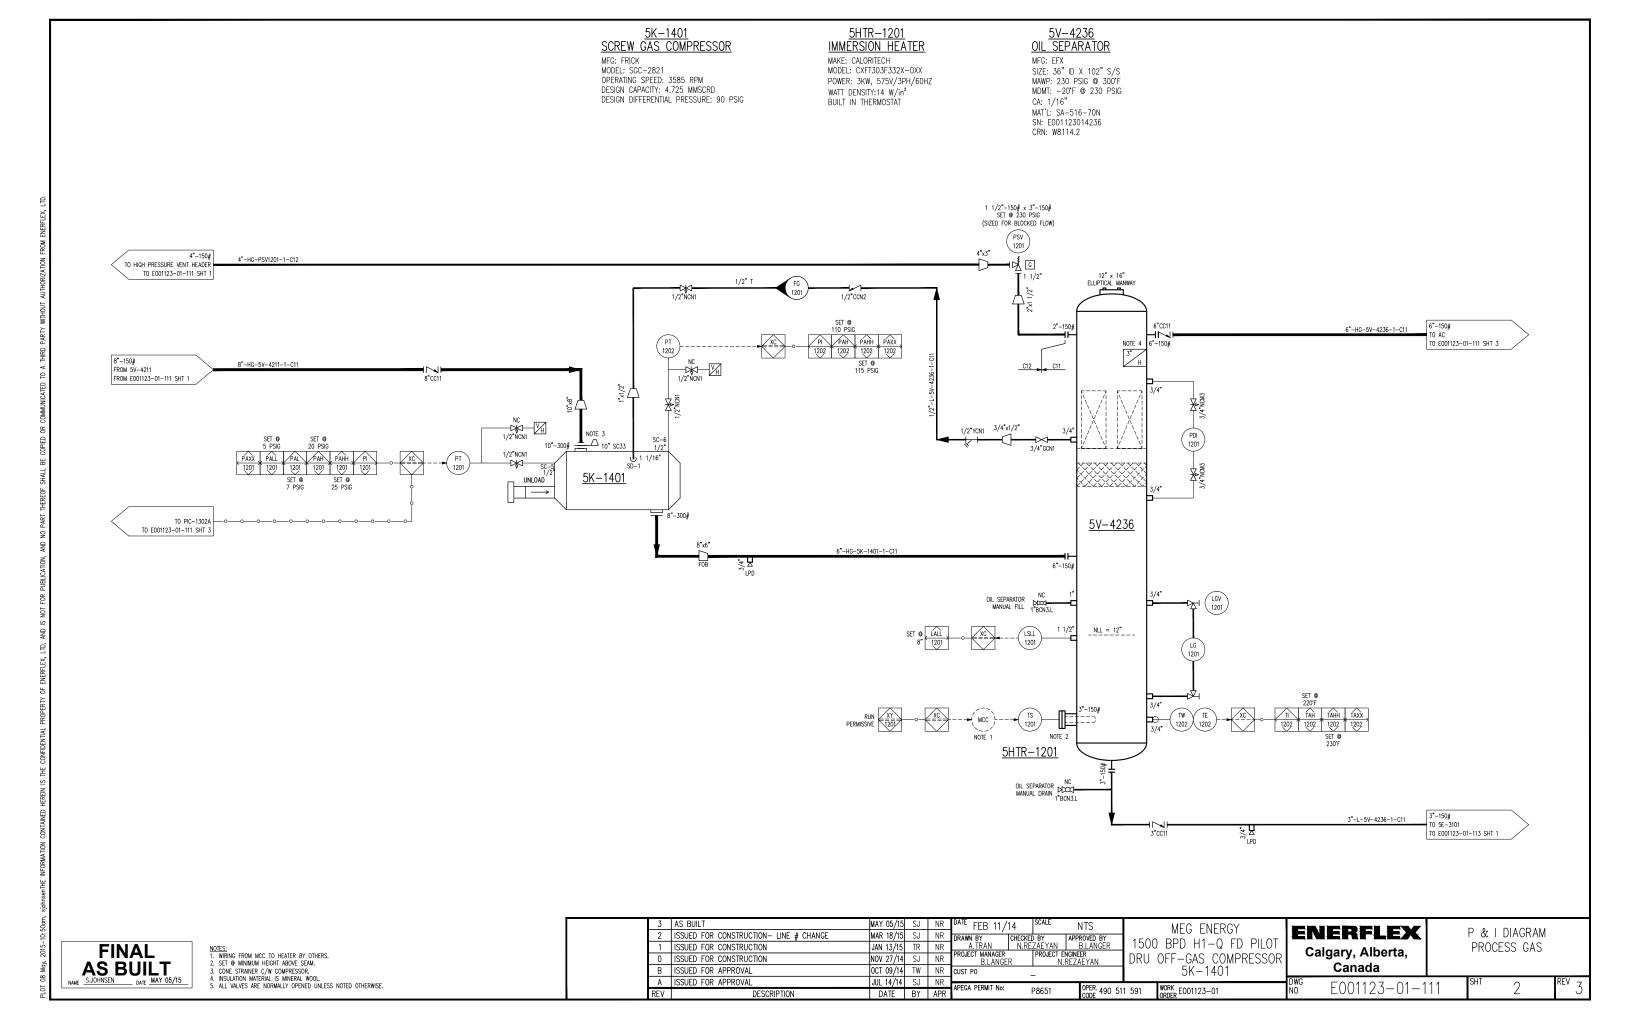

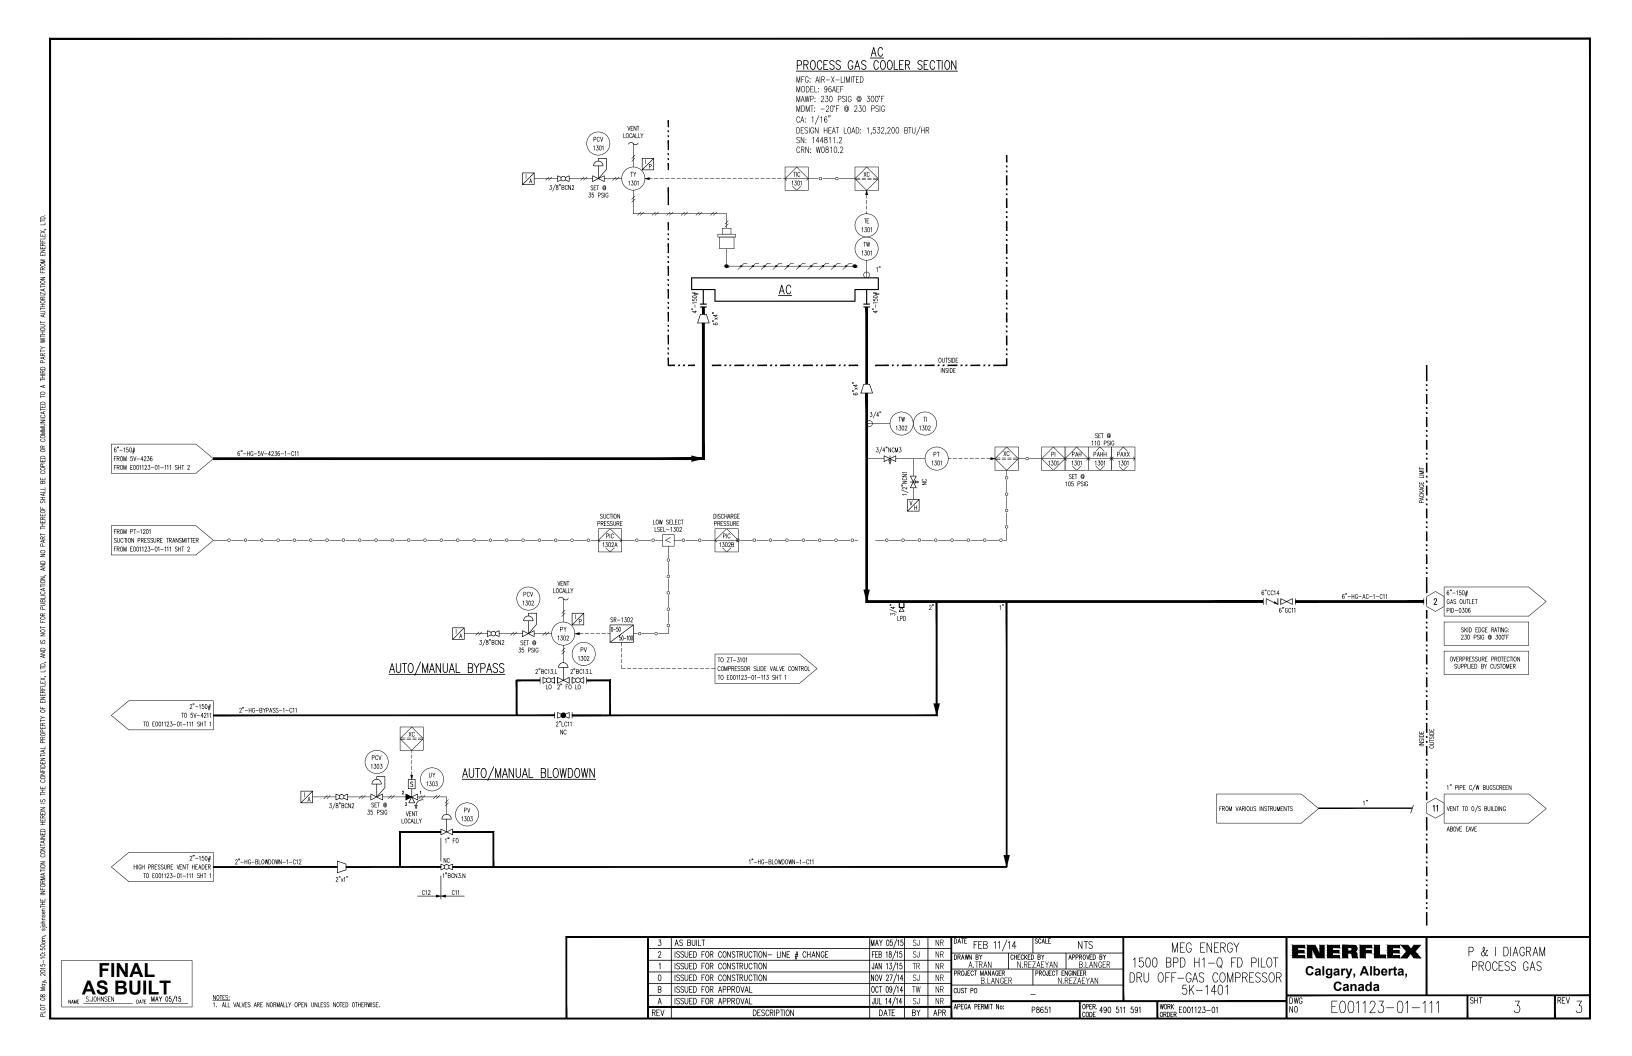

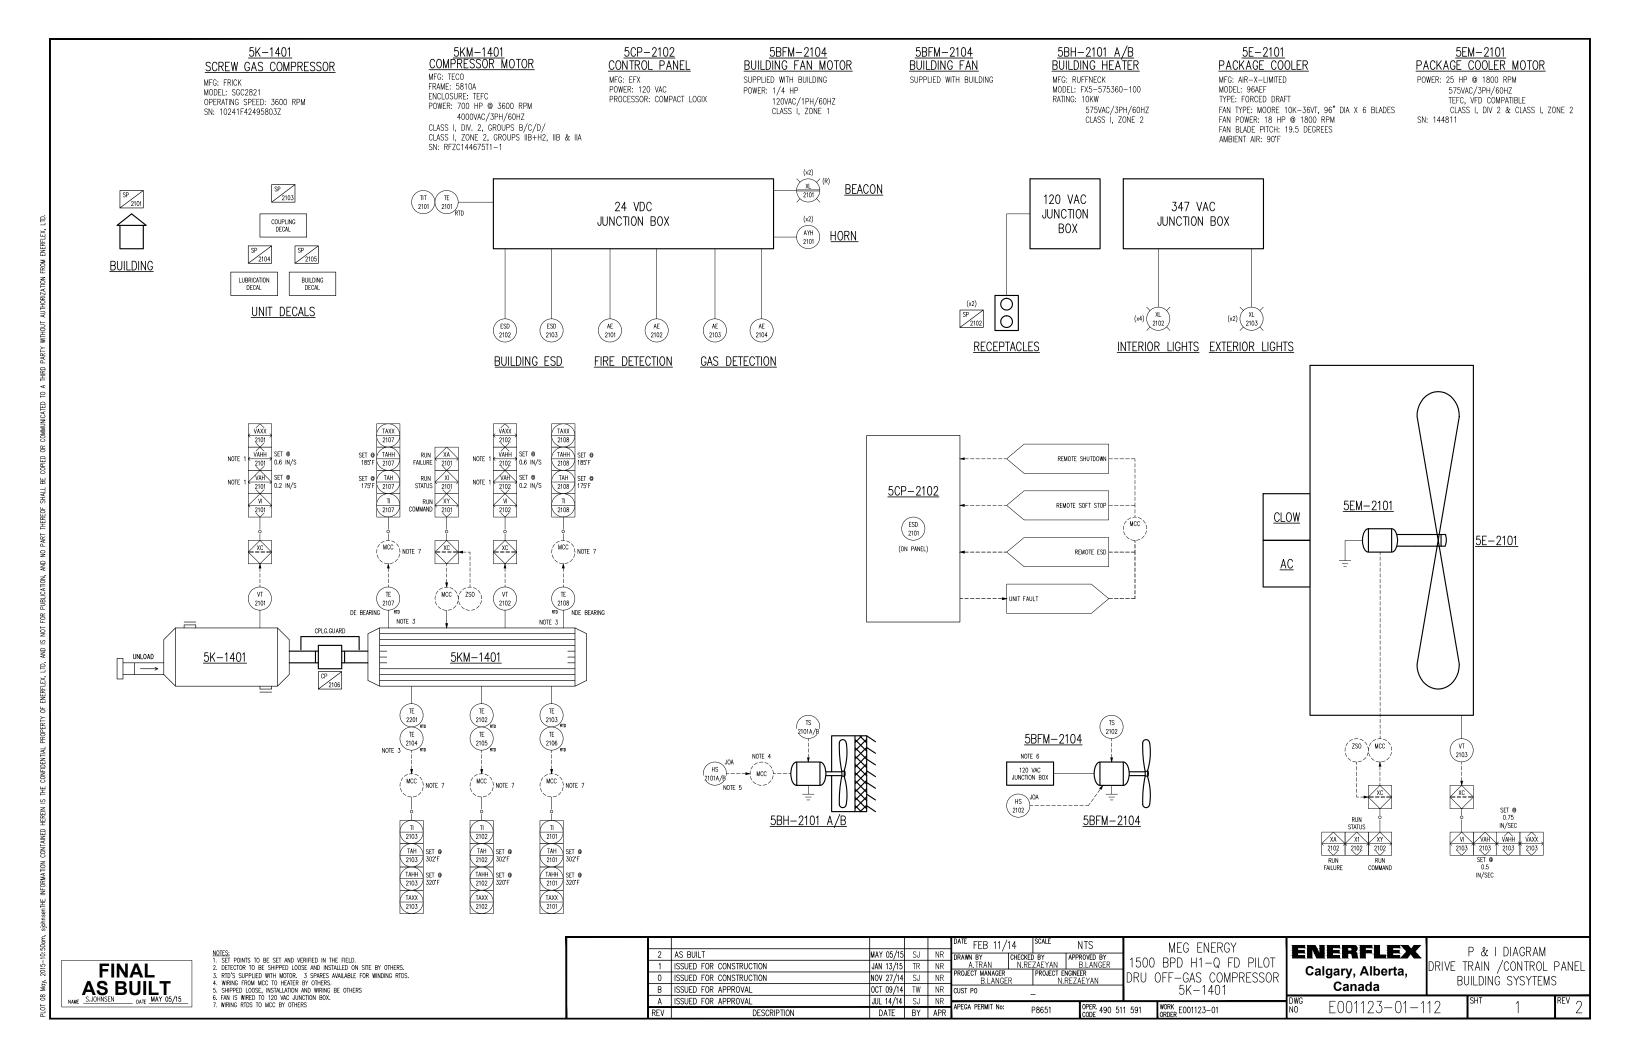


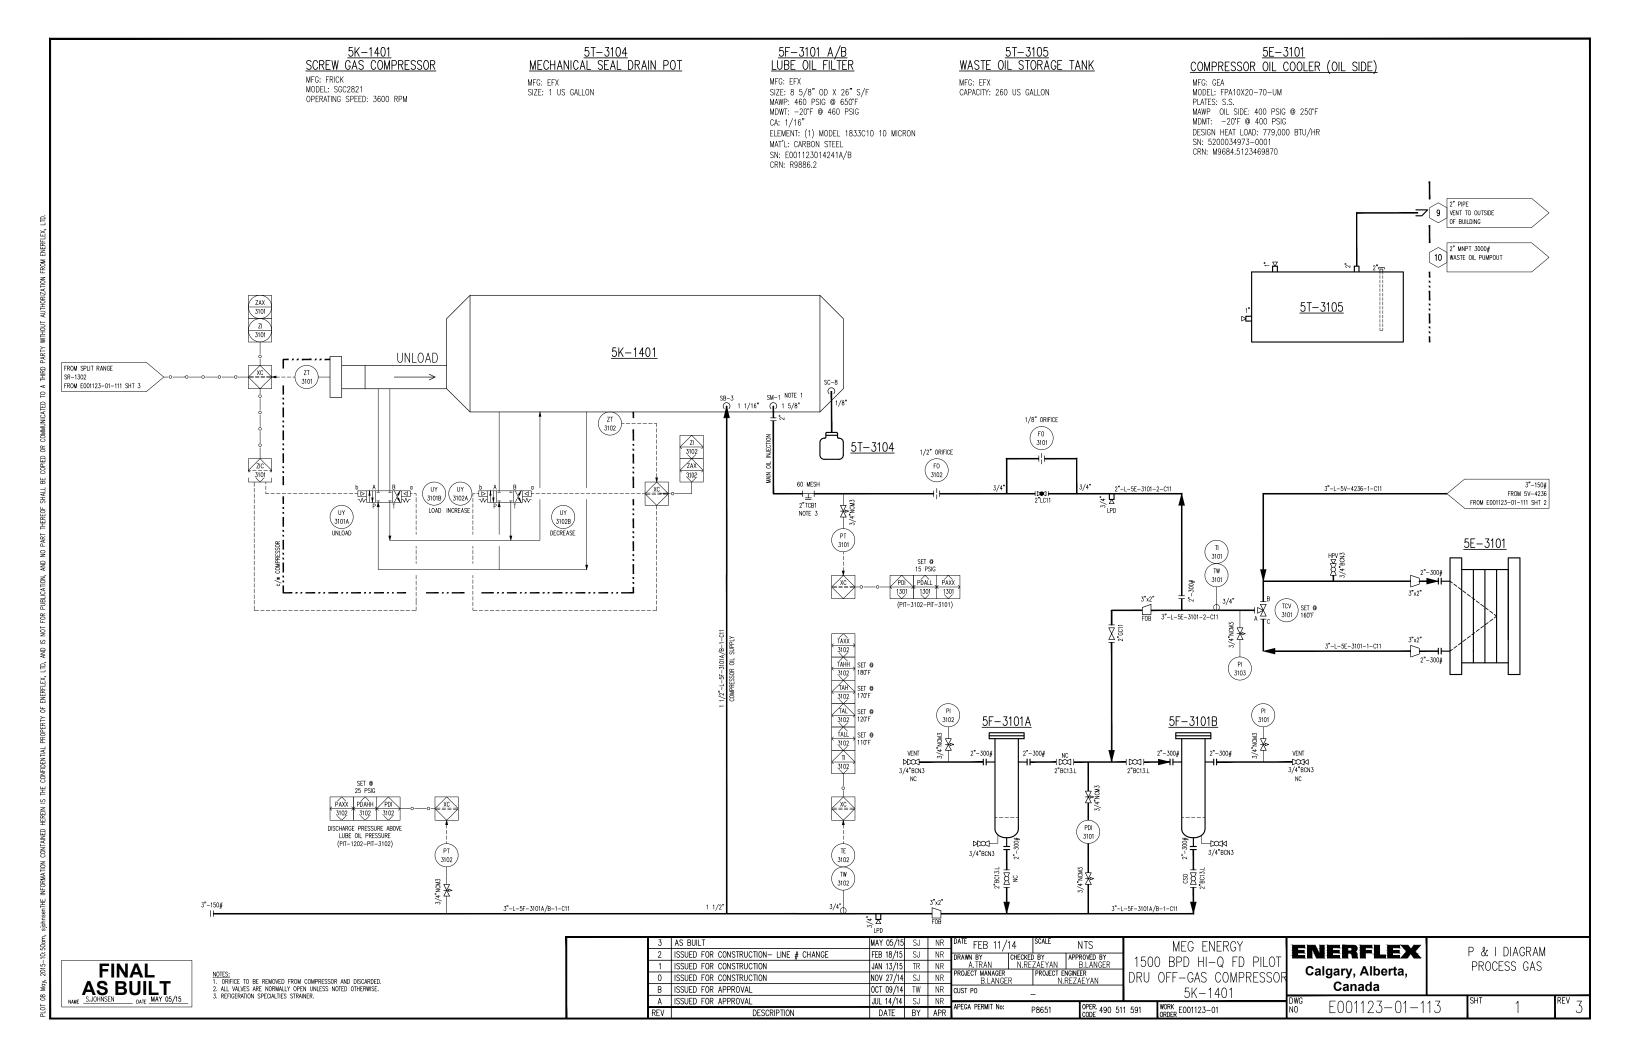


<u>5T-6103</u> <u>WASTE GLYCOL STORAGE TANK</u> <u>5E-3101</u> COMPRESSOR OIL COOLER (GLYCOL SIDE) 5P-6101 GLYCOL CIRCULATION PUMP 5PM-6101 GLYCOL CIRCULATION PUMP MOTOR 5T-6101 GLYCOL EXPANSION TANK CLOW GLYCOL COOLER SECTION MFG: EFX CAPACITY: 260 US GALLONS MAKE: WEG POWER: 5 HP @ 1150 RPM MFG: GEA MAKE: VIKING MFG: EFX MAWP: 14 PSIG @ 300°F CAPACITY: 10 US GALLONS VOLUME REQUIRED FOR FILL LEVEL: 6 US GALLONS MDMT: -20°F @ 14 PSIG SN: 144811.1 MODEL: FPA10X20-70-UM PLATES: S.S. MAWP: 400 PSIG @ 250°F MODEL: SG-41436 575VAC/3PH/60HZ EXPLOSION PROOF CLASS I, ZONE 1 FLOW: 79 US GPM C/W ELECTRIC MOTOR MDMT: -20°F @ 400 PSIG DESIGN HEAT LOAD: 779,000 1/2" T LGV 6101 GLYCOL VENT
(MOUNTED AT
OPERATOR HEIGHT) OVERPRESSURE COOLANT BURP OUTLET (PLASTIC TUBE MOUNT BELOW GRATING LEVEL) (LG) (6101) <u>5T-6101</u> 1/2" T GLYCOL FILL DOG-3/4"BCN3 (MOUNTED AT OPERATOR HEIGHT) 3/8" T SLOPE NO TRAPS 5PM-6101 TW 6101 5E-3101 3"-G-CLOW-1-C01 RUN RUN COMMAND STATUS ZS0 5P-6101 3"UC11 3"-150# 3"-150# T 3"YC11 SP 6102 <u>CLOW</u> 3"-G-CLOW-2-C01 3"-G-CLOW-2-C01 2" PIPE VENT TO OUTSIDE OF BLDG. 7 2" MNPT 3000# WASTE GLYCOL PUMPOUT 8 <u>5T-6103</u> ^{TE} FEB 11/14 MEG ENERGY **ENERFLEX** P & I DIAGRAM 2 AS BUILT DRAWN BY CHE A.TRAN N PROJECT MANAGER B.LANGER CHECKED BY APPROVED BY N.REZAEYAN B.L.ANGER PROJECT ENGINEER R.REZAEYAN 1500 BPD H1-Q FD PILOT COOLING SYSTEM 1 ISSUED FOR CONSTRUCTION JAN 13/15 SJ NR **FINAL** Calgary, Alberta, DRU OFF-GAS COMPRESSOR 5K-1401 0 ISSUED FOR CONSTRUCTION CLOW COOLER SECTION **AS BUILT** Canada OCT 09/14 TW NR NOTES:

1. WIRING AND MCC FOR PUMP CONTROL AND POWER ARE BY OTHERS.

2. TIE IN AS CLOSE AS POSSIBLE TO PUMP. B ISSUED FOR APPROVAL A ISSUED FOR APPROVAL JUL 14/14 SJ NR E001123-01-116 APEGA PERMIT No: OPER. 490 511 591 WORK E001123-01

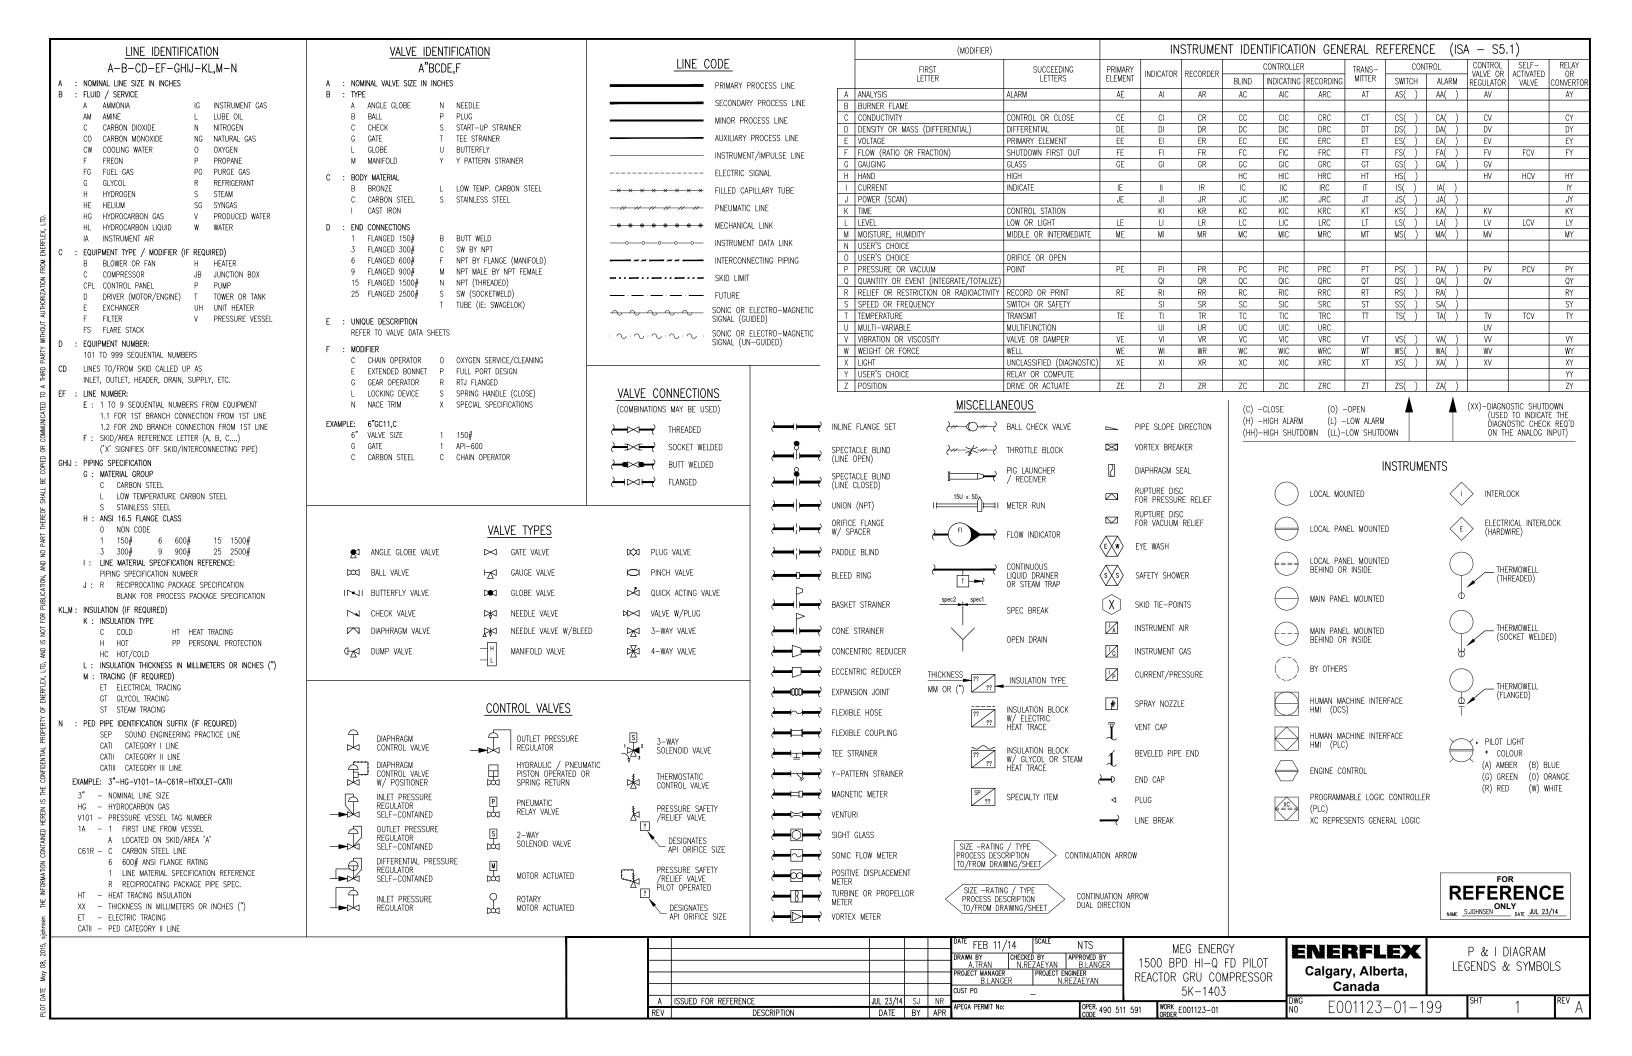

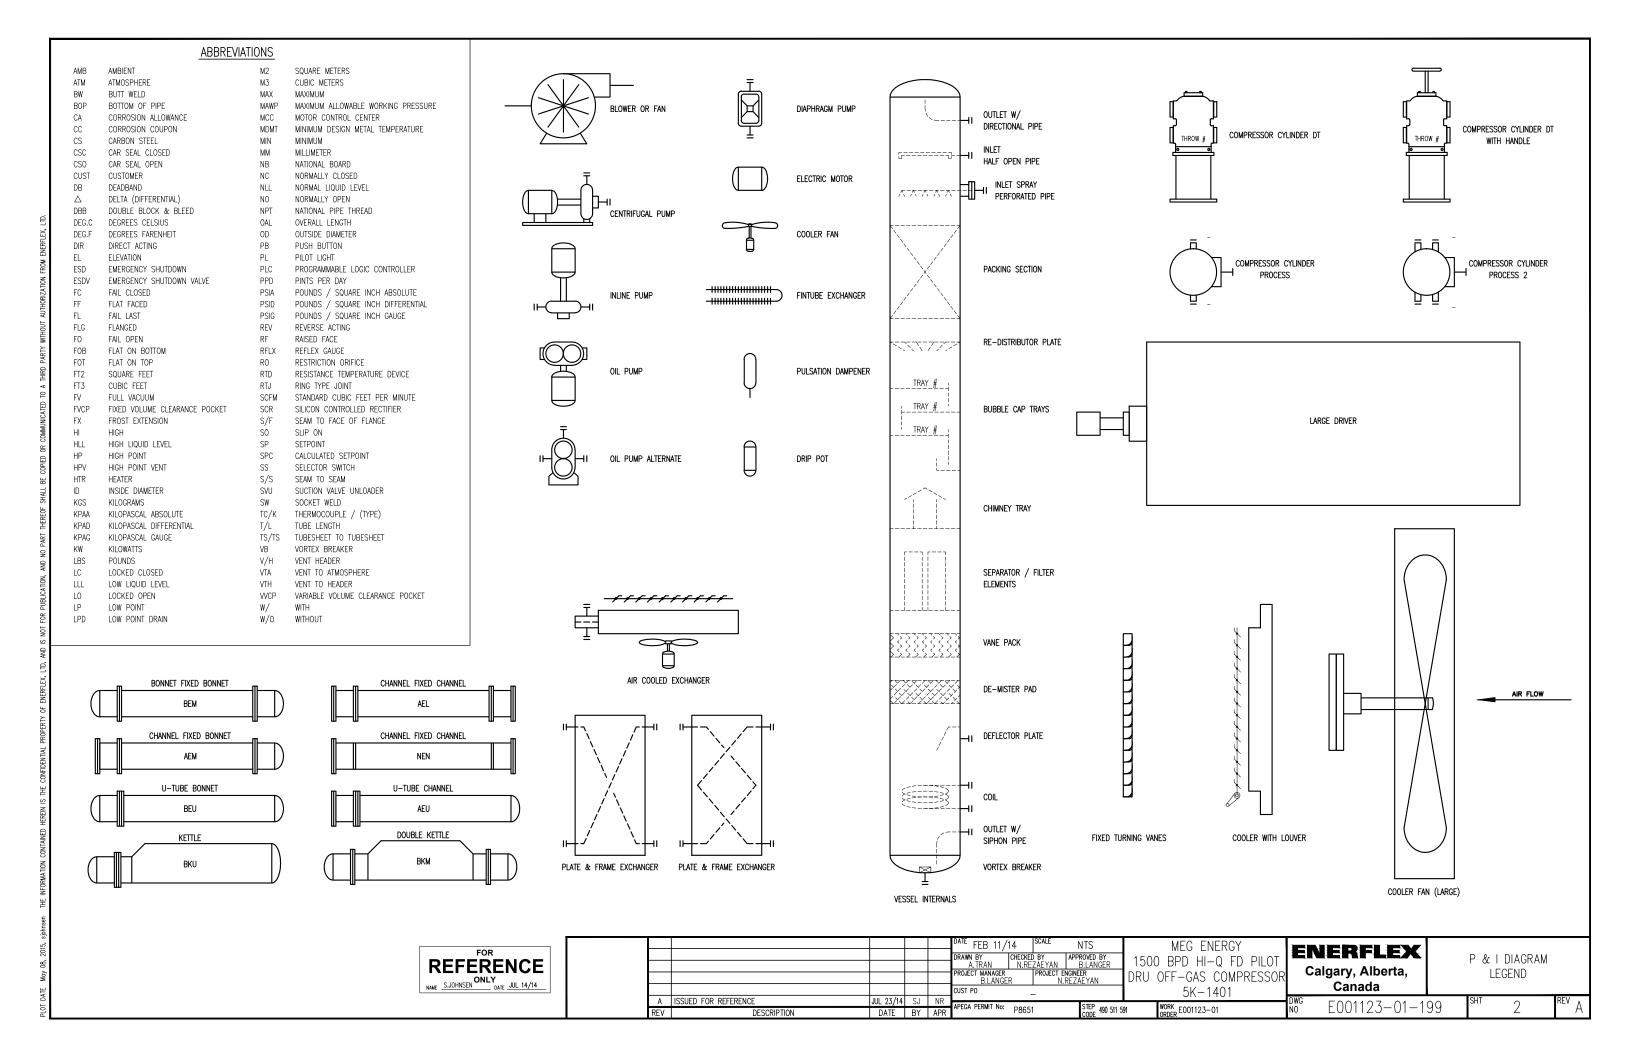

P&ID's (P.Eng Stamped)

PROJECT DESCRIPTION

ONE (1) DRU OFF-GAS COMPRESSOR PACKAGE FOR: MEG ENERGY

LOCATION NAME: HI-Q FIELD DEMO PILOT, BRUDERHEIM, AB LSD: SE 1/4-34-055-20 W4M

FABRICATED BY:

ENERFLEX LTD.

CALGARY, ALBERTA, CANADA

TANK CAPACITIES

GLYCOL (CLOW) EXPANSION TANK: GLYCOL STORAGE TANK: WASTE OIL STORAGE TANK:

20 US GALLONS 260 US GALLONS 260 US GALLONS POWER REQUIREMENTS

COMPRESSOR MOTOR (5KM-1401) SUCTION FILTER DRAIN PUMP MOTOR (5PM-1101)

BUILDING HEATER (5BH-2101 A/B) BUILDING FAN MOTOR (5BFM-2104)

GLYCOL CIRCULATION PUMP MOTOR (5PM-6101)

COOLER MOTOR (5EM-2101) IMMERSION HEATER (5HTR-1201)

CONTROL PANEL: FIRE DETECTION: GAS DETECTION: INT. LIGHTS: EXT. LIGHTS:

RECEPTACLES:

VOL: 4000 VAC/3PH/60HZ 700 HP VOL: 575 VAC/3PH/60HZ 1.5 HP VOL: 575 VAC/3PH/60HR 10 KW VOL: 120 VAC/1PH/60HZ 0.25 HP VOL: 575 VAC/3PH/60H≥ 5 HP VOL: 575VAC/3PH/60HZ\25 HP VOL: 575 VAC/3PH/60HX 3KW VOL: 120 VAC AMPS: NOM: 5 VOL: 24 VDC AMPS: NOM: 5 VOL: 24 VDC AMPS: NOM: 5 VOL: 347 VAC AMPS: NOM: 1.7

SYSTEM CONSUMABLES

COMPRESSOR LUBE OIL: EFX S5-150, 135 US GALLONS GLYCOL:

INSTRUMENT AIR:

50% ETHYLENE INHIBITED GLYCOL/WATER SOLUTION, 46 US GALLONS 300 SCFD

DESIGN CRITERIA & APPLICABLE CODES

SITE ELEVATION:

BAROMETRIC PRESSURE: AMBIENT TEMPERATURE:

PROCESS INLET:

PROCESS FINAL DISCHARGE:

INSTRUMENT AIR:

MAXIMUM PRESSURE QUALITY

APPLICABLE CODE: CODE PIPING

NON-CODE PIPING VESSEL **EXCHANGER** STRUCTURAL

MINIMUM PRESSURE

MAXIMUM

MINIMUM

DESIGN

DESIGN

BOITING

FLANGES

REGISTRATION:

MISCELLANEOUS:

ELECTRICAL: SUITABLE FOR USE IN: 3000 FT ABOVE MEAN SEA LEVEL

13.2 PSIA 90°F -20°F

230 PSIG @ 300°F 230 PSIG @ 300°F

90 PSIG 150 PSIG

FILTERED/DRY, 50°F MAXIMUM DEW POINT

B31.3 - 2012 EFX CO1, 1mm (0.039") CA ASME SECTION VIII, DIV 1 ASME SECTION VIII, DIV 1

CWB CEC 2012

ELECTRICAL VESSEL AB **GASKETS**

CG TYPE, SPIRAL WOUND, GRAPHITE FILLED, 316SS STUDS - SA-193-B7, NUTS - SA-194-2H PROCESS PIPE CARBON STEEL

UTILITY PIPE CARBON STEEL

RAISED FACE (UNLESS OTHERWISE NOTED) RIGID ALUMINUM CONDUIT

CLASS I, DIV. 2, GROUP D & CLASS I, ZONE 2, GROUP IIA

DESIGN SPECIFICATION:

ENERFLEX LTD. (EFX) SCOPE OF SUPPLY ON THIS PROJECT CONSISTS OF ONE SCREW SKIDDED GAS COMPRESSOR PACKAGE.

PACKAGE CONSISTS OF ONE (1) TECO 700HP EMD DRIVING A FRICK SGC-2821, ONE STAGE, DRU OFF-GAS COMPRESSOR.

PRIMER (VESSELS, PIPING, STRUCTURAL)

PAINT (VESSELS, PIPING,

PROCESS PIPING (SWEET):

VOL: 347 VAC AMPS: NOM: 0.8 VOL: 120 VAC AMPS: NOM: 30

-FIN-1A, CLOVERDALE 703 SERIES, ECOPRIME WATER-BASED

PRIMER, GREY

-FIN-1A, CLOVERDALE 703 SERIES, ECOLOGIC WATER-BASED INDUSTRIAL ENAMEL, F-34 WARM GREY

STRUCTURAL) -10% RADIOGRAPHIC TESTING

> -1/16" CORROSION ALLOWANCE -NO PWHT -SSPC-SP3

-NO PICKLING FLARE HEADER PIPING (SOUR):

-100% RADIOGRAPHIC TESTING -1/8" CORROSION ALLOWANCE

-PWHT -SSPC SP3

VESSELS:

-5% RADIOGRAPHIC TESTING - RT2 -UT ON ALL CAT. 'D' WELDS -1/16" CORROSION ALLOWANCE

-NO PWHT -SSPC-SP3 -NO PICKLING

-NO PICKLING

March 19, 2015

ISSUED FOR CONSTRUCTION NAME T.RAWLYCK DATE JAN 13/15

			_		DATE FEB 13/14 DRAWN BY ICHECK	SCALE ED BY	NTS APPROVED BY	MEG ENERGY	E	NERFLEX	Р &	I DIAGRAM	Л
1	ISSUED FOR CONSTRUCTION	JAN 13/15	TR	NR	A.TRAN N.F		RPPROVED BY B.LANGER	1500 BPD H1-Q FD PILOT	ے ا	algary, Alberta,	PROJEC	T DESCRIP	TION
0	ISSUED FOR CONSTRUCTION	NOV 27/14	SJ	NR	PROJECT MANAGER B.LANGER	PROJECT ENG	EZAEYAN	DRU OFF-GAS COMPRESSOR	~	COLOR SECURITION SECUR	20	OVERVIEW	500000000
В	ISSUED FOR APPROVAL	OCT 09/14	TW	NR	CUST PO	_		5K-1401		Canada	Q.	OVERVIEW	
A	ISSUED FOR APPROVAL	JUL 14/14	SJ	NR	APEGA PERMIT No:		Longo	MADIA	DWG	E001107 01 0	OO SHT	1	REV 4
REV	DESCRIPTION	DATE	BY	APR	APEGA PERMIT NO:	P8651	OPER. 490 51	1 591 WORK E001123-01	NO	E001123-01-0	99	1	

TUBING SPECIFICATIONS

	PROCESS TUBING	UTILITY TUBING				
TUBING SPECIFICATION	ENERFLEX: G-S04-CSZ-CS-S16-375	TUBING SPECIFICATION	ENERFLEX: G-S04-CSZ-CS-S16-375			
TUBING MATERIAL	304SS	TUBING MATERIAL	304SS			
FITTING MATERIAL	ZINC PLATED CARBON STEEL C/W SS BACK FERRULE	FITTING MATERIAL	ZINC PLATED CARBON STEEL C/W SS BACK FERRULE			
OUTSIDE DIAMETER	MINIMUM WALL THICKNESS	OUTSIDE DIAMETER	MINIMUM WALL THICKNESS			
1/4"	0.035"	1/4"	0.035"			
3/8"	0.035"	3/8"	0.035"			
1/2"	0.049"	1/2"	0.049"			
		3/4"	0.065"			
-	_	1"	0.083"			

SMALL BORE NPT & SW PIPING & FITTINGS

PROCESS & SCREW PIPING SPECIFICATIONS

			SWI	EET SERVICE (-20-6	50°F,1/1	6"CA)		
EEV DIDE C	DECIFICATION		PIP	ING	BRIDA.	FITTI	NGS	
ELY LILE 2	PECIFICATION	NPT		SW		NPT & THREADOLET	SW & SOCKOLET	
044	450#	1/2"	160	1/2"-1 1/2"	XS	1/07 07	Live to the second	
C11	150#	3/4"-2"	XS	2"	STD	1/2"-2"	3000#	
					115118.			

UTILITY PIPING SPECIFICATIONS

EEV DIDE ADEQUEATION	LOW PRESSURE UTILITY SERVICE PIPING FITTINGS								
EFX PIPE SPECIFICATION	NPT		SW		NPT & THREADOLET	SW & SOCKOLET			
CO1 NON-CODE	1/2"-3/4"	160	1/2"-1 1/2"	XS	1 /0" 0" 7000//	1 /0" " 7000//			
COT NON-CODE	1"-2"	XS	2"	STD	1/2"-2" 3000#	1/2"-2" 3000#			


Mand 19, 2015


ISSUED FOR CONSTRUCTION


NAME T.RAWLYCK DATE JAN 13/15


				DRAWN BY ICHECKED BY	IN IO	MEG ENERGY	ENERFLEX	P&I DIAGRAM
1	ISSUED FOR CONSTRUCTION	JAN 13/15 TR	NR	A.TRAN N.REZAE PROJECT MANAGER PRO		1500 BPD HI-Q FD PILOT	Calgary, Alberta,	PROJECT DESCRIPTION
0	ISSUED FOR CONSTRUCTION	NOV 27/14 SJ	NR	B.LANGER	N.REZAEYAN	DRU OFF-GAS COMPRESSOR		& OVERVIEW
В	ISSUED FOR APPROVAL	OCT 09/14 TW	NR	CUST PO		5K-1401	Canada	a overview
A	ISSUED FOR APPROVAL	JUL 14/14 SJ	NR		Tapen		DWG F001107 01 0	OO SHT O REV 1
REV	DESCRIPTION	DATE BY	APR	APEGA PERMIT No: P86	51 OPER 490 5	11 591 WORK E001123-01	E001123-01-0	99 2 1


Transport Commercial actions and the second second

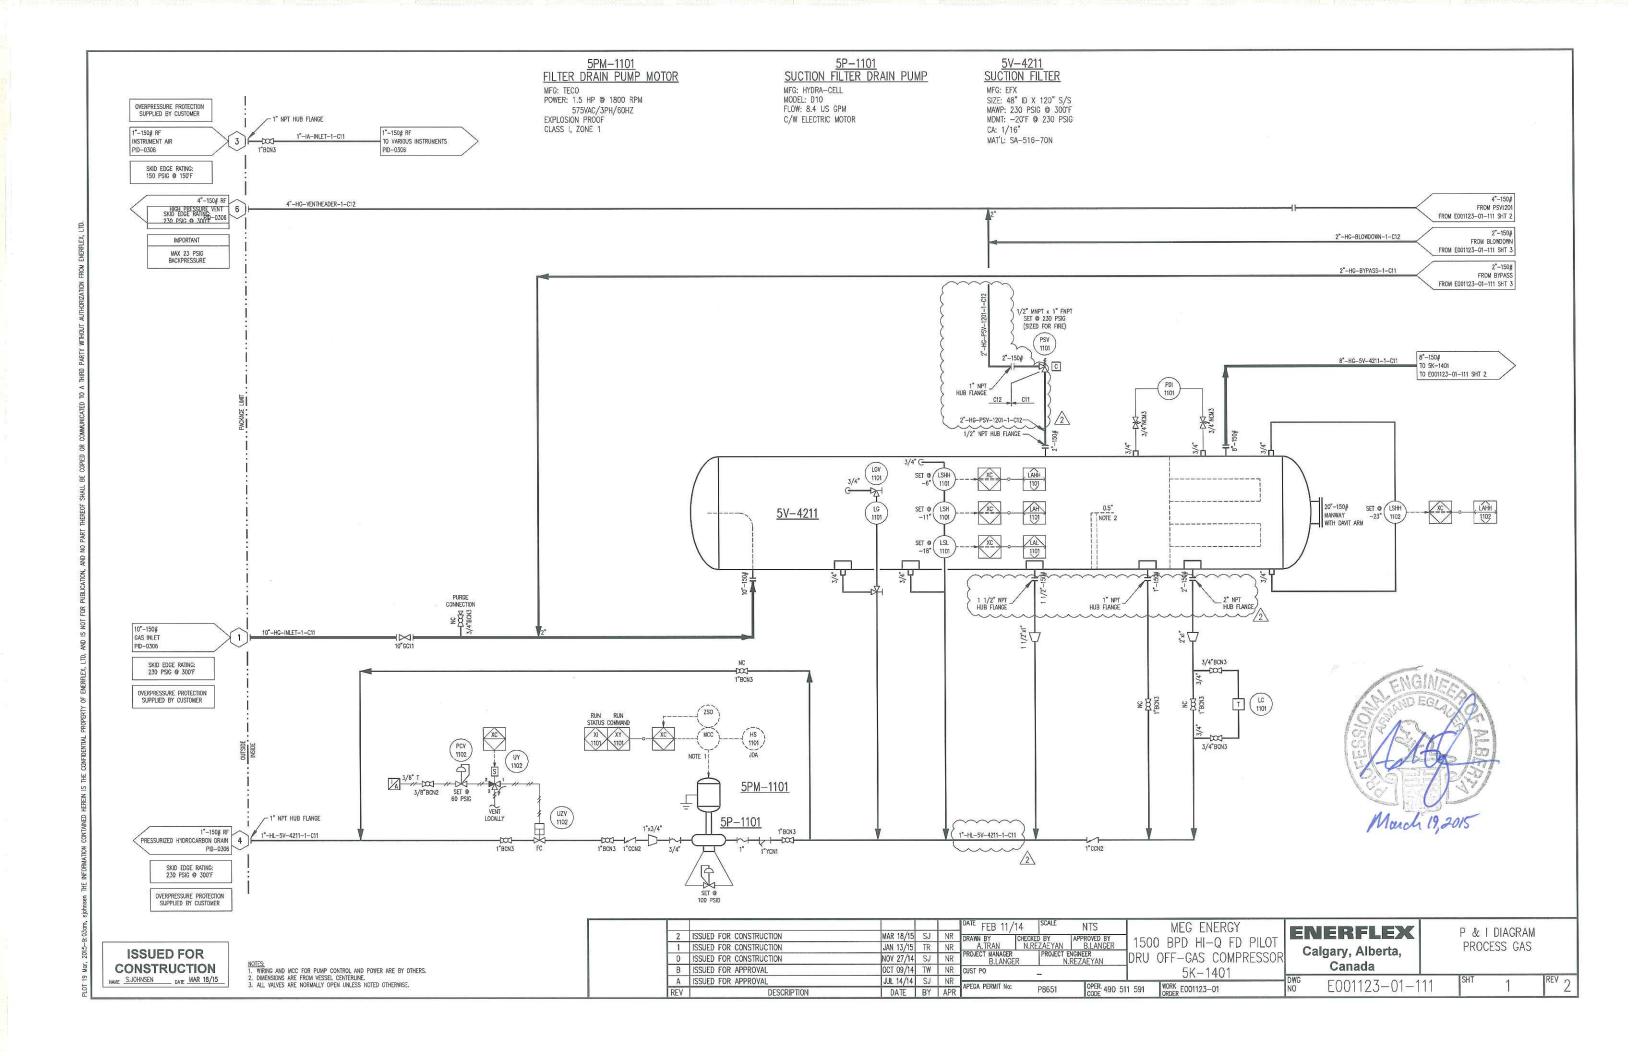


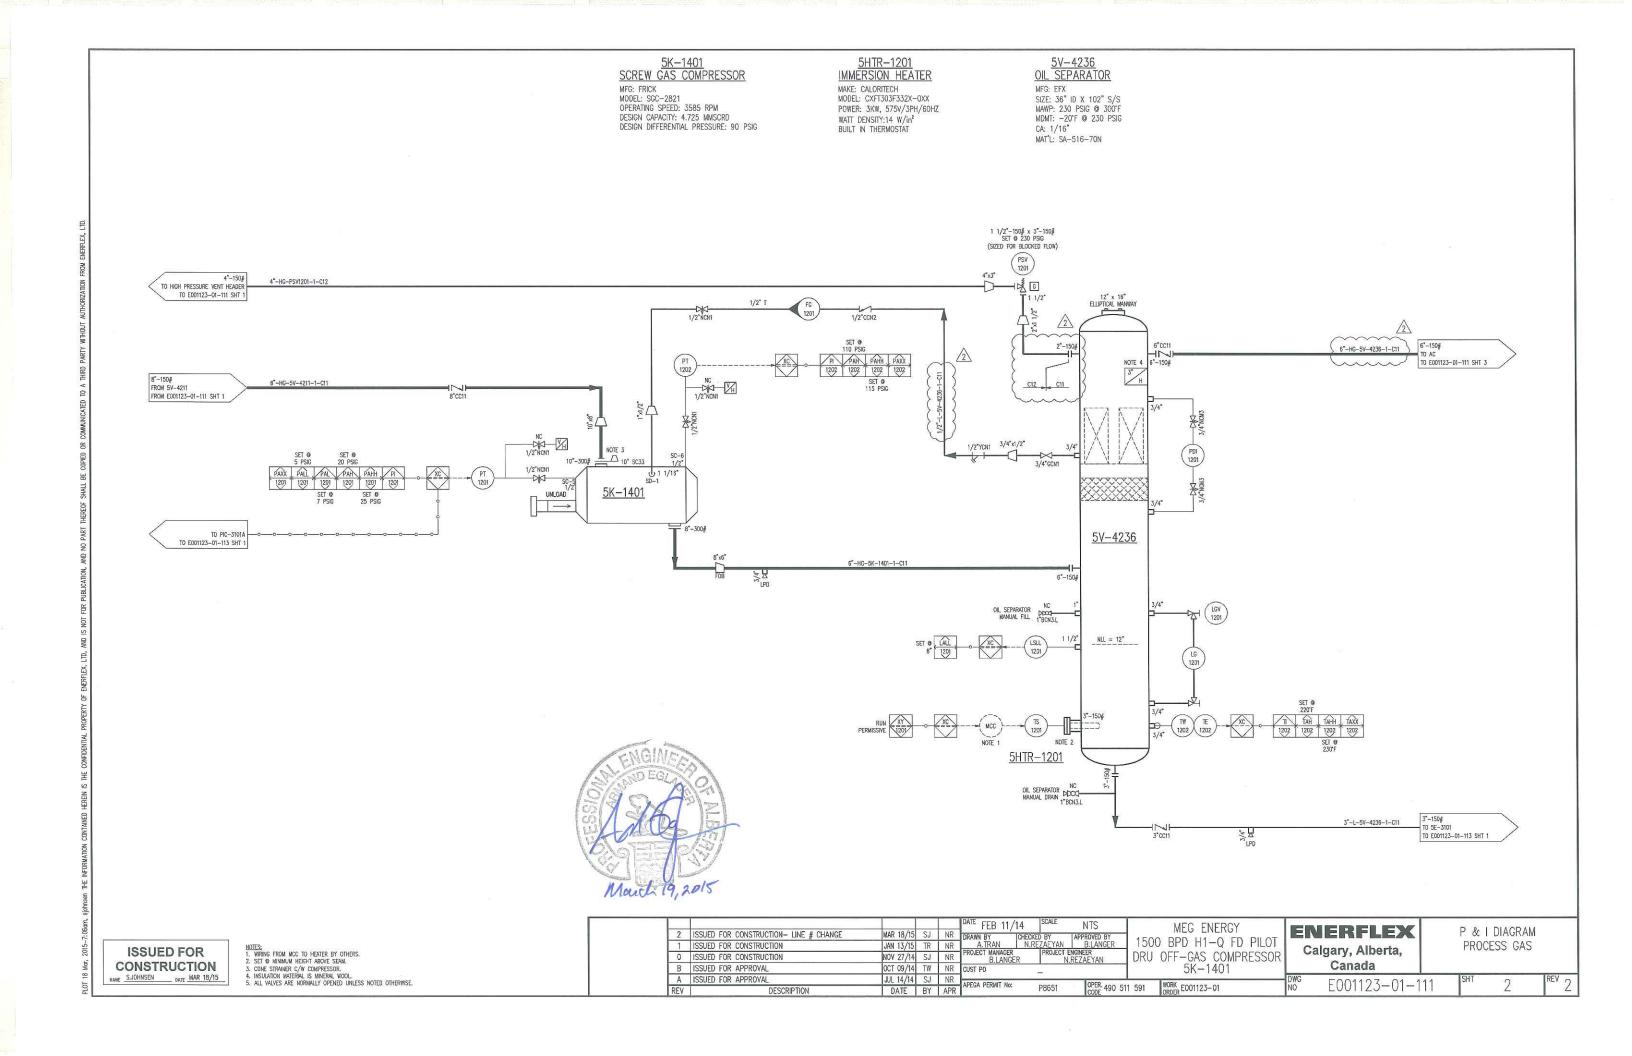


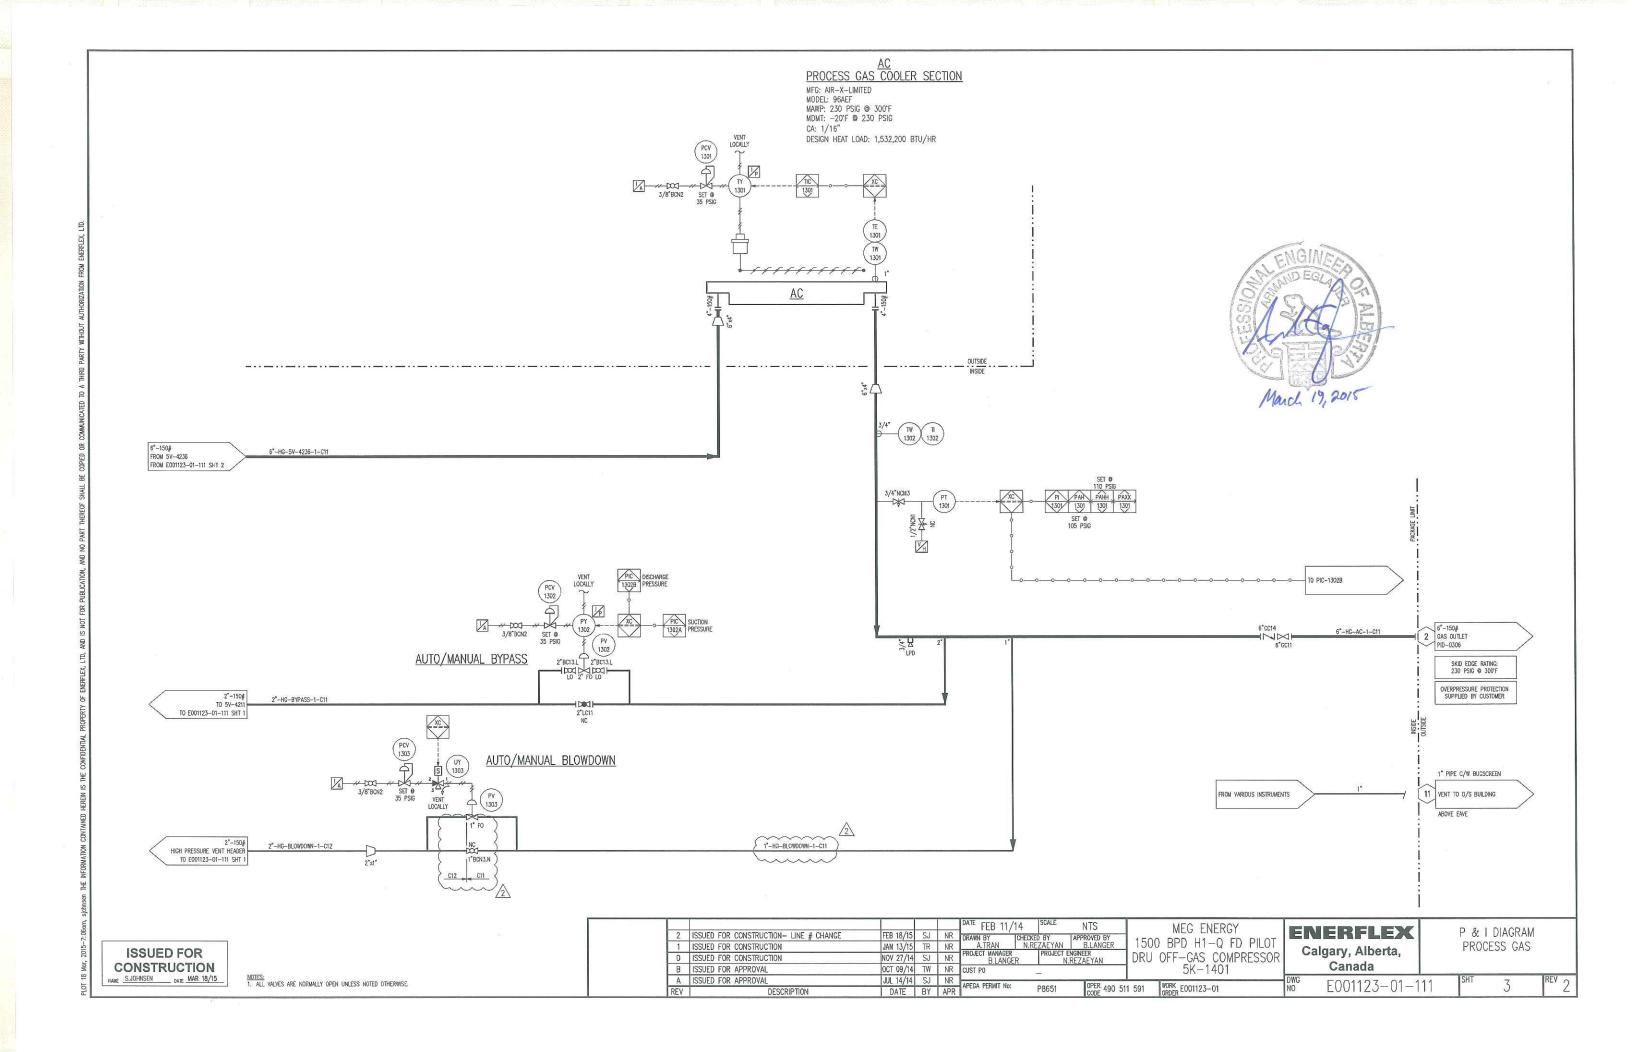


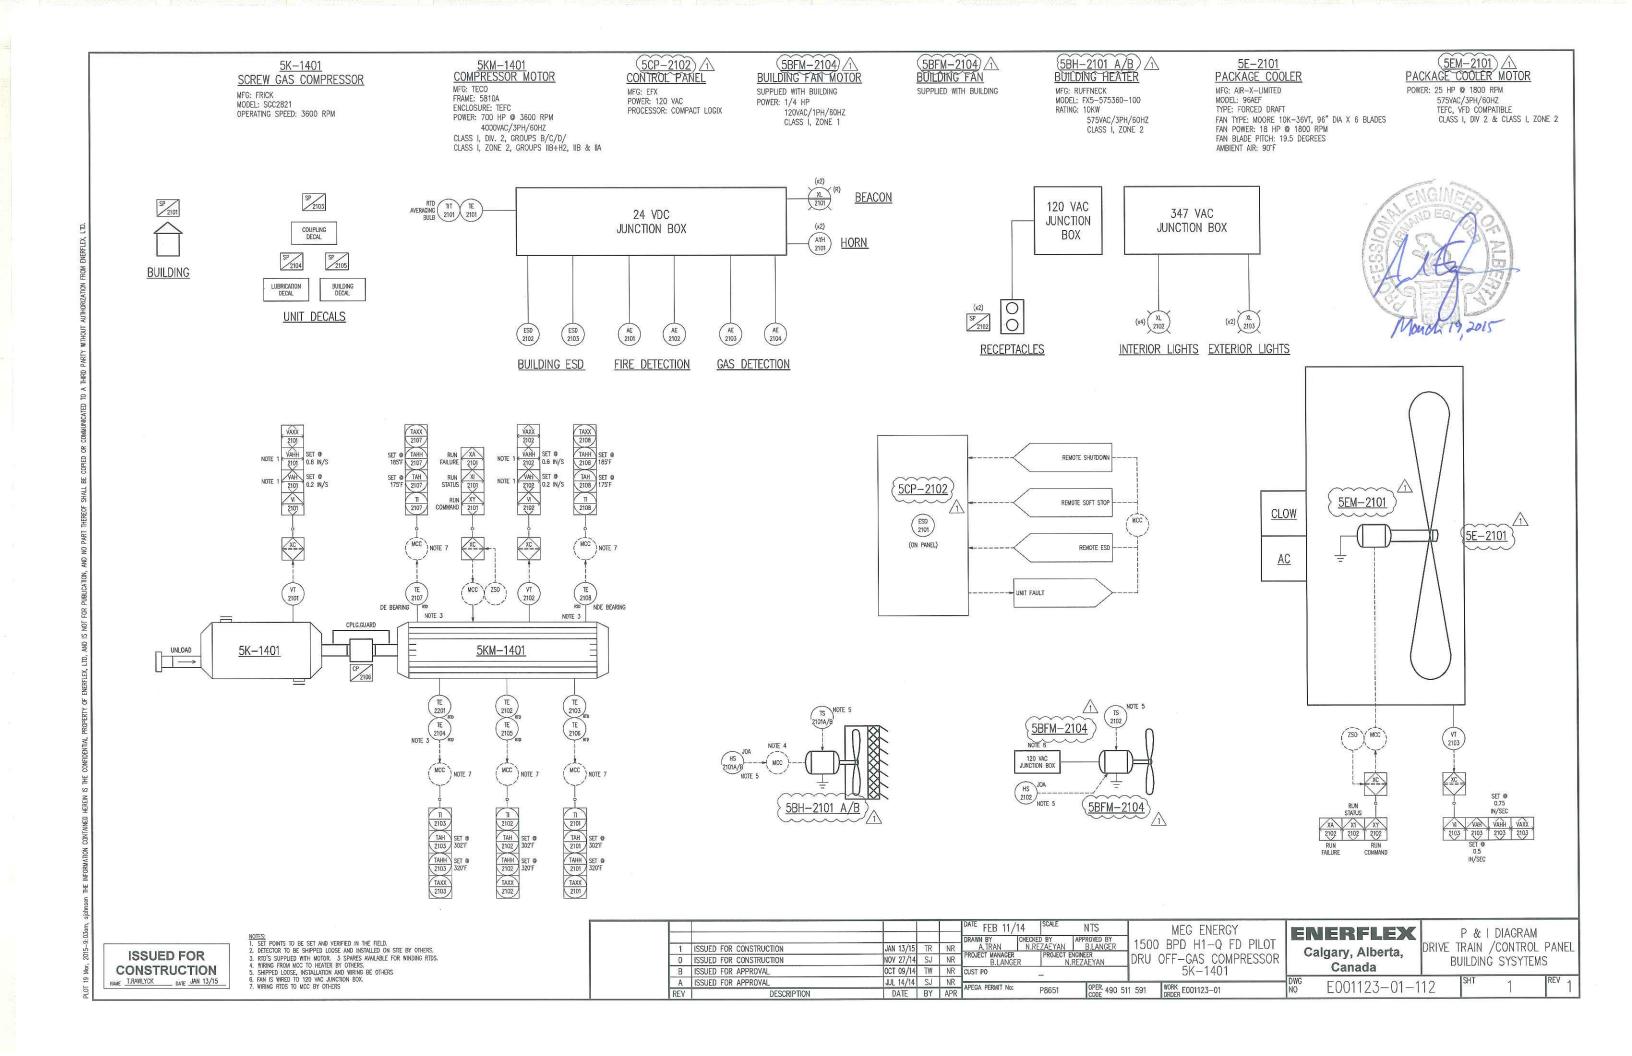

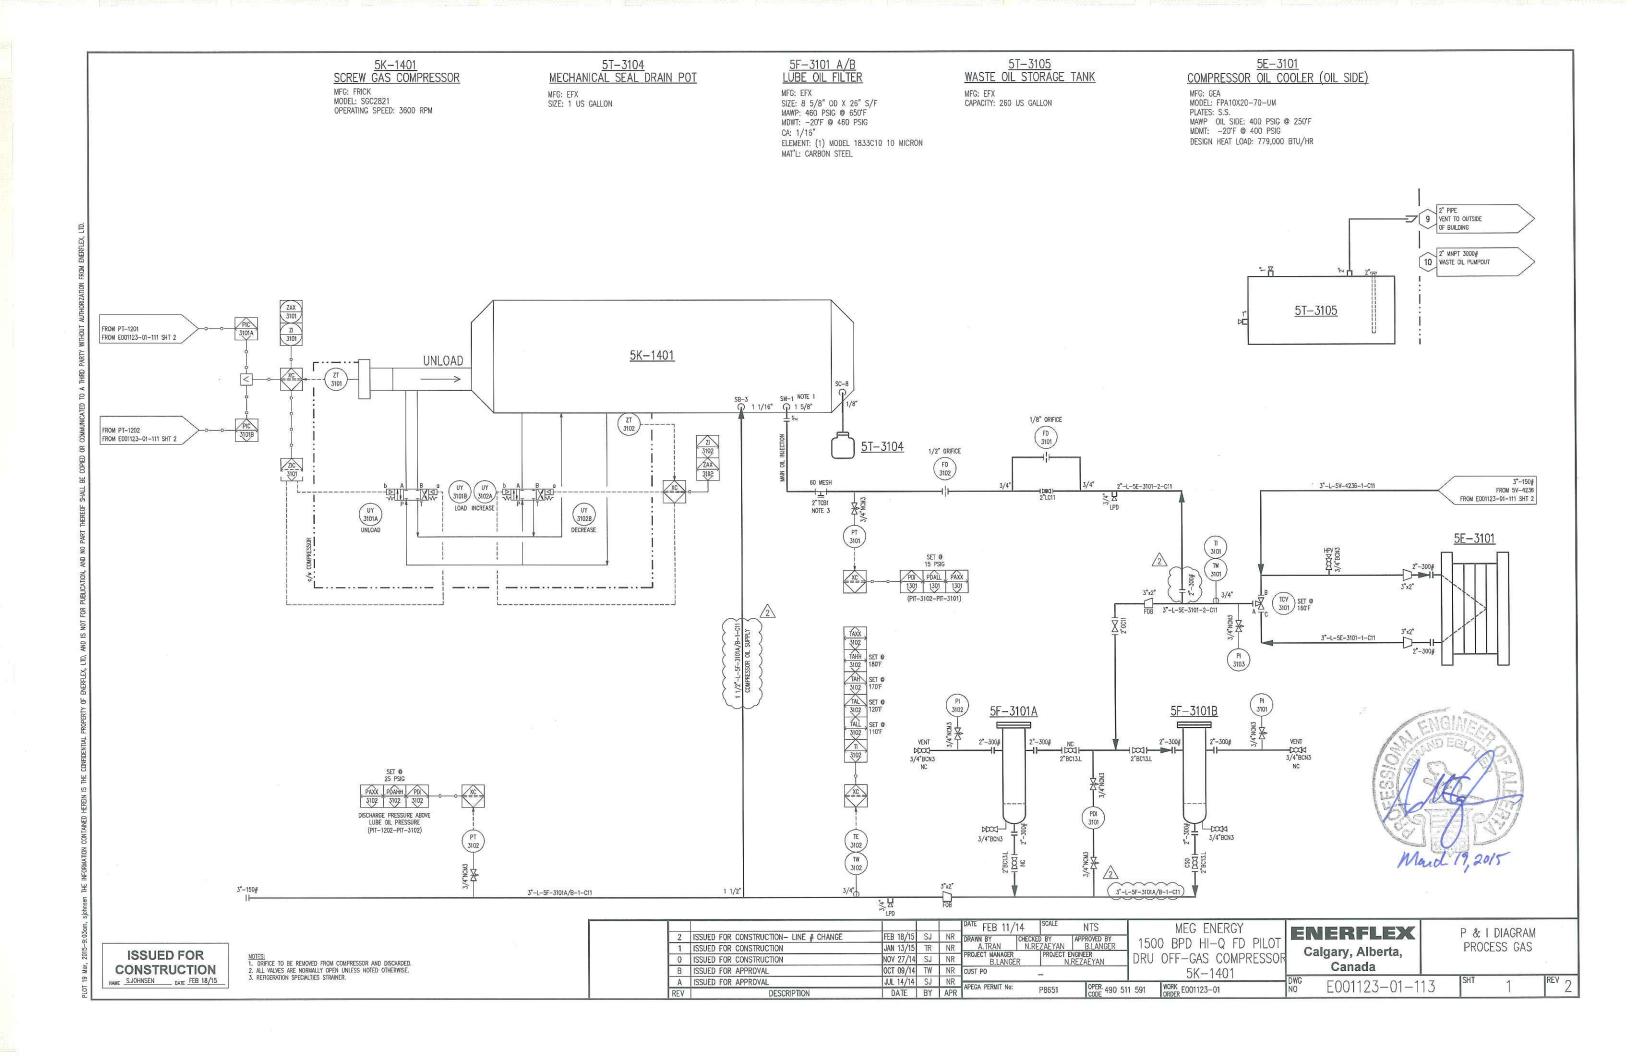

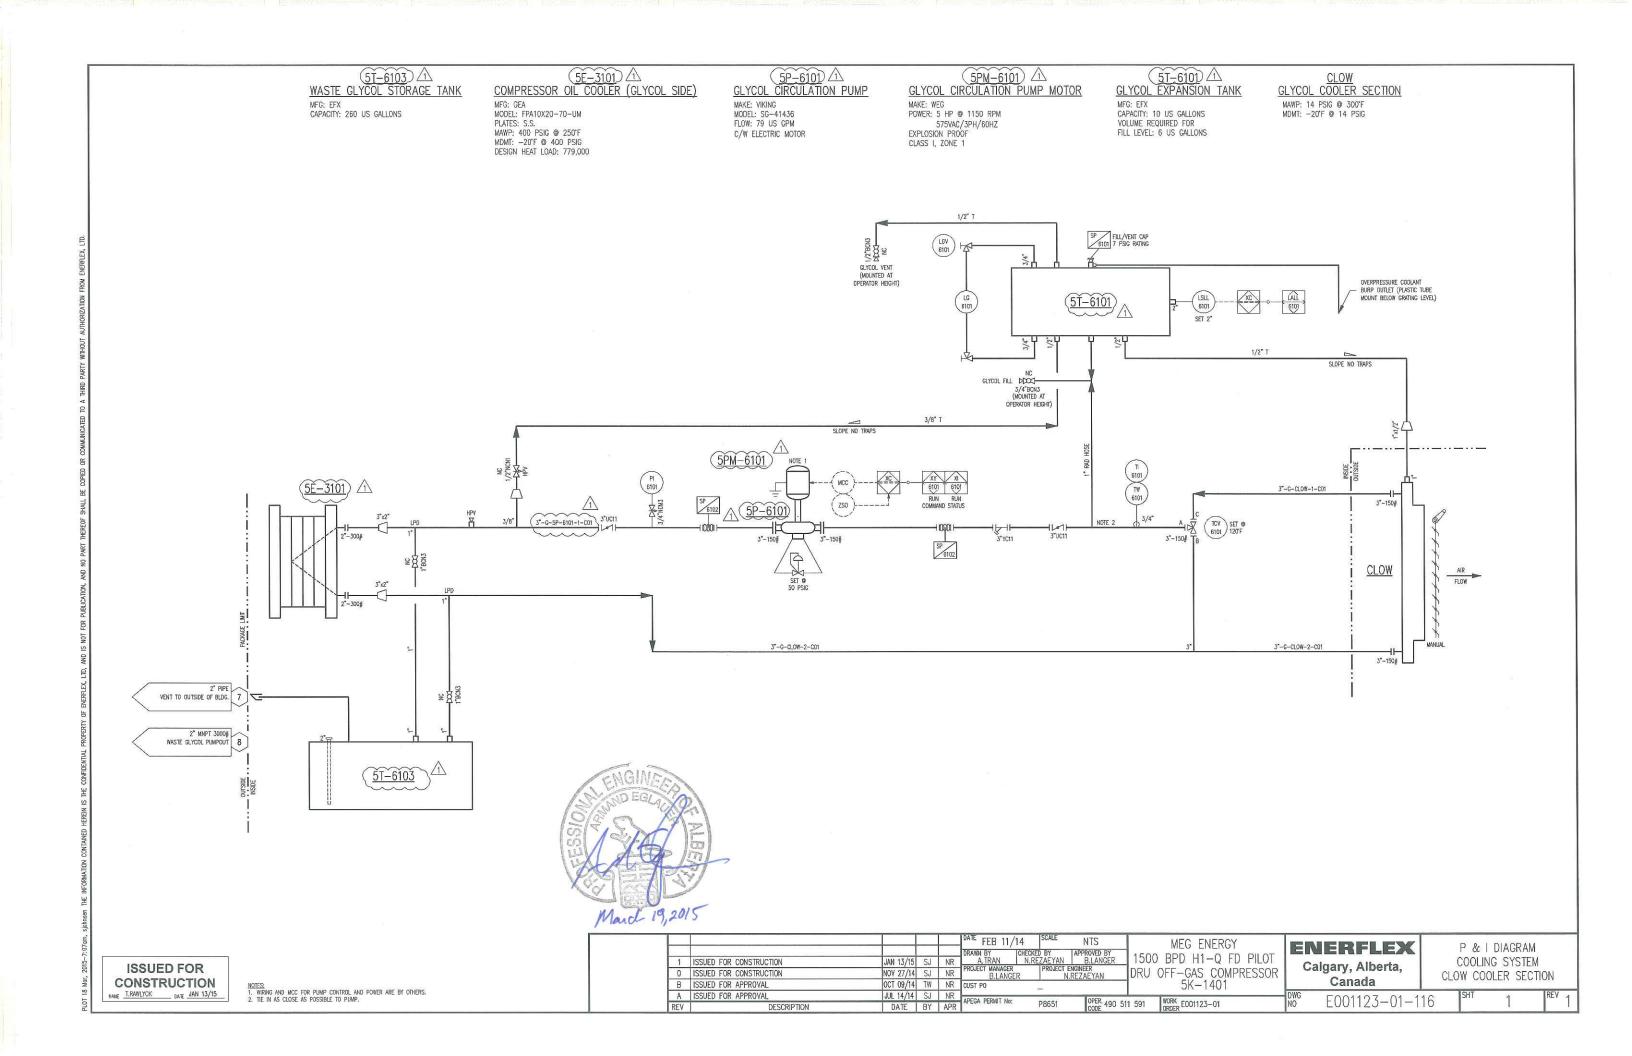

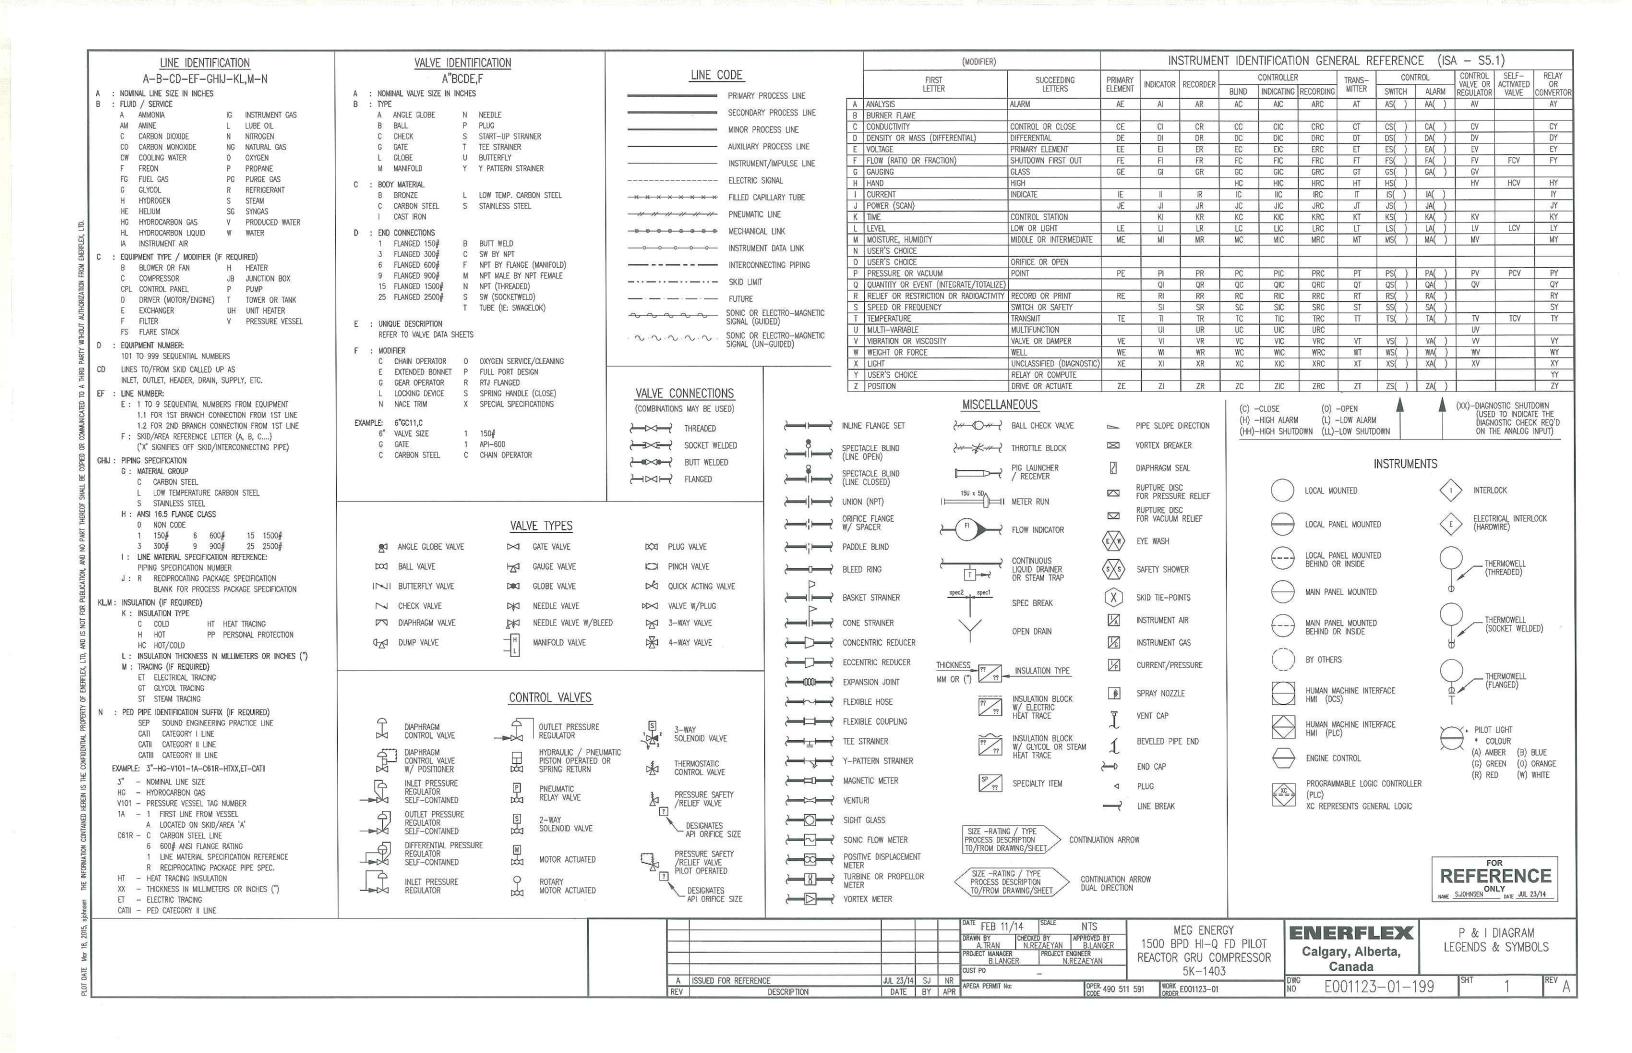

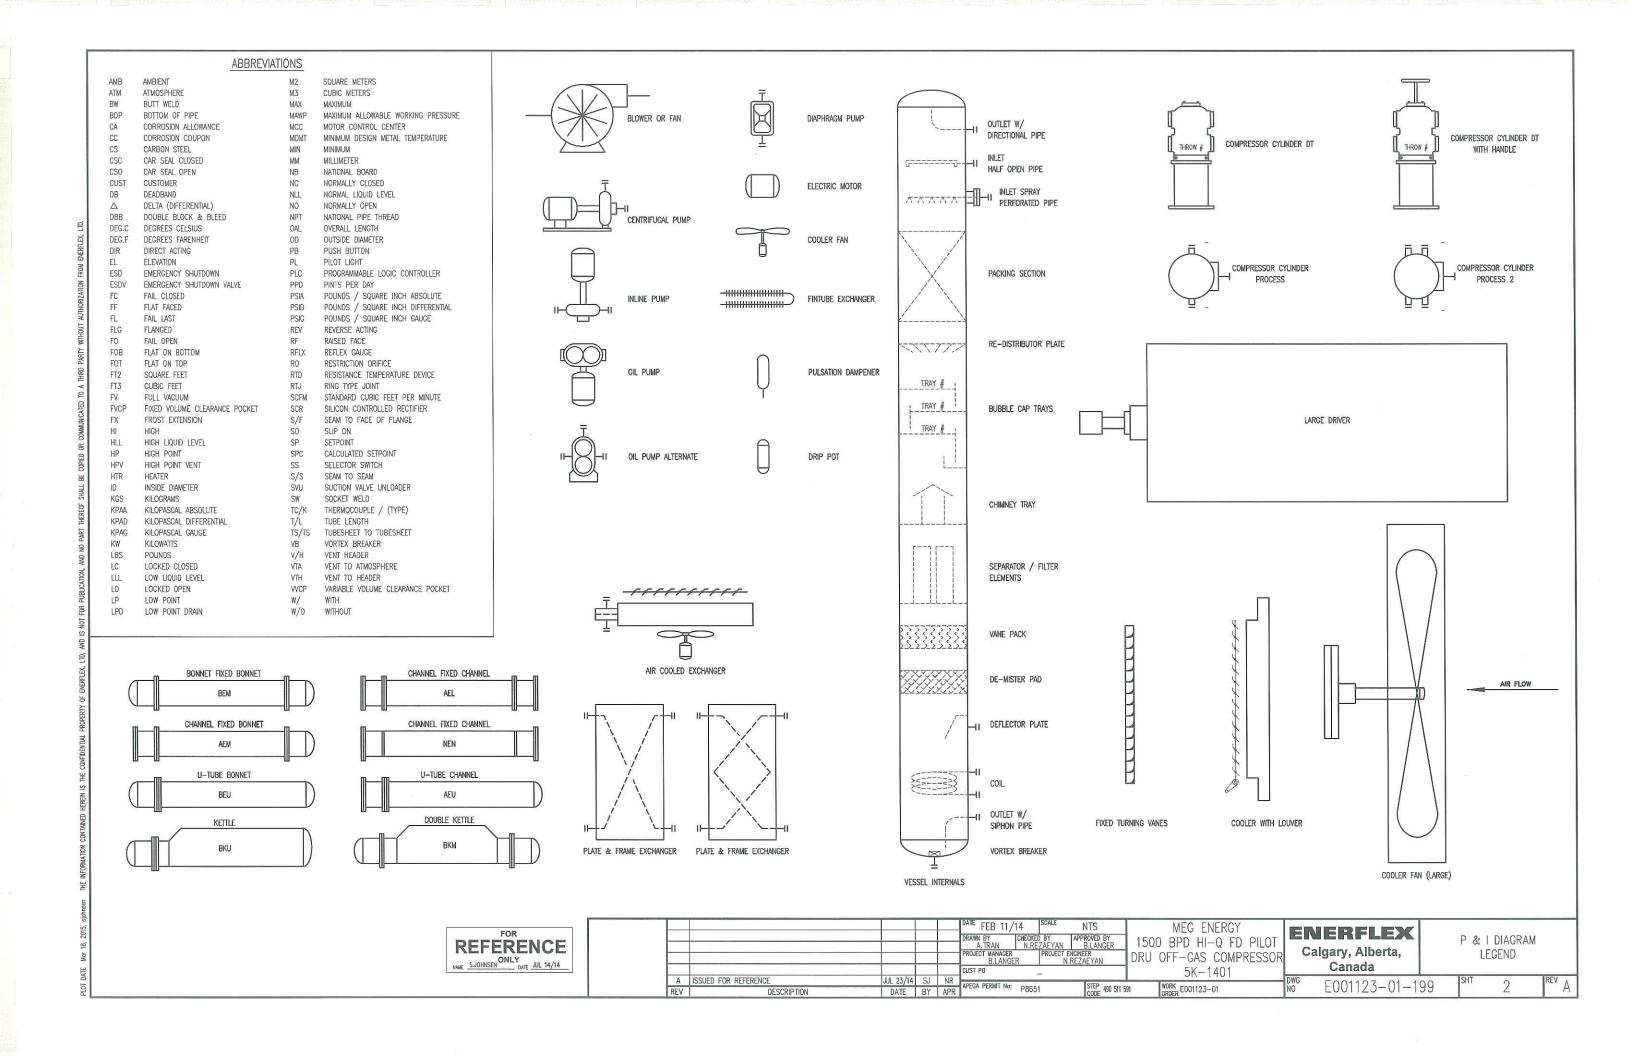

Line List (P.Eng Stamped)

LINE LIST

Document Version 0, 22-Sept-2014

ENERFLEX

		Revisions								
Cuataman	MEC Engrave	NO.	ISSUE	DATE	By	Checked	Approved	1		
Customer:	MEG Energy	1	For Registration	16/03/2015	Nika Rezaeyan		AFE	1		
							160	٦N		
Project:	1500 BPD HI-Q FD Pilot				_					
	DRU Off-gas Compressor							F		
	EK 4404							J.		
	5K-1401									
								1		
EFX Job #:	E001123-01									
LIX JOB #.	2001120-01							4		

NOTE: THE FLOW DRAWINGS AND THIS LINE LIST
HAVE BEEN P. ENG STAMPED BASED ON THE
ORIGINAL PACKAGE DESIGN DURING
FABRICATION. ENERFLEX IS NOT RESPONSIBLE
FOR THE CHANGES THAT MAY HAVE OCCURRED
DURING THE FIELD INSTALLATION AND
OPERATION OF THE UNIT

ENGINE SOEG


A		AF	100	DAIT	AL.	DOCE	a
44.1	- P- E-	5 6A P		11/11	32	P865	


																		1	1	the state of
P&ID	P&ID Rev.	Line Number	SERVICE	SIZE (INCH)	PIPE SCHEDULE	FROM	то	PIPE SPEC	ANSI CLASS	DESIGN PRESSURE (psig)	DESIGN TEMP. (°F)	C.A. (INCH)	TEST PRESSURE (psig)	TYPE OF TEST	X-RAY (%)	PIPE MATERIAL	FLANGE MATERIAL	IMPACT TEST (Y/N)	PWHT (Y/N)	NOTES
E001123-01-111 SHT 1	2	10"-HG-INLET-1-C11	Sweet Hydrocarbon gas	10"	STD (40)	Gas inlet connection 1	Suction Filter 5V-4211	C11	150	230	300	1/16"	400	Hydro	10%	SA-106-B	SA-105N	N	N	
E001123-01-111 SHT 1 & SHT 2	2	8"-HG-5V-4211-1-C11	Sweet Hydrocarbon gas	8"/ 10"	STD (40)	Suction Filter 5V-4211	Compressor 5K-1401	C11	150	230	300	1/16"	400	Hydro	10%	SA-106-B	SA-105N	N	N	
E001123-01-111 SHT 2	2	6"-HG-5K-1401-1-C11	Sweet Hydrocarbon gas	8"/ 6"	STD (40)	Compressor 5K-1401	Oil separator 5K-4236	C11	150	230	300	1/16"	400	Hydro	10%	SA-106-B	SA-105N	N	N	
E001123-01-111 SHT 2 & SHT 3	2	6"-HG-5V-4236-1-C11	Sweet Hydrocarbon gas	6"/ 4"	STD (40)	Oil separator 5K-4236	Process gas cooler AC	C11	150	230	300	1/16"	400	Hydro	10%	SA-106-B	SA-105N	N	N	
E001123-01-111 SHT 3	2	6"-HG-AC-1-C11	Sweet Hydrocarbon gas	4"/ 6"/ 2"	STD (40)	Process gas cooler AC	Gas outlet connection 2, \	C11	150	230	300	1/16"	400	Hydro	10%	SA-106-B	SA-105N	N	N	
E001123-01-111 SHT 3 & SHT 1	2	2"-HG-BYPASS-1-C11	Sweet Hydrocarbon gas	2"	STD (40)	6"-HG-AC-1-C11	10"-HG-INLET-1-C11	C11	150	230	300	1/16"	400	Hydro	10%	SA-106-B	SA-105N	N	N	
E001123-01-111 SHT 3	2	1"-HG-BLOWDOWN-1-C11	Sweet Hydrocarbon gas	1"	xs	6"-HG-AC-1-C11	2"-HG-BLOWDOWN-1-C12	C11	150	230	300	1/16"	253	Pneumatic	N/A	SA-106-B	SA-105N	N	N/A	Threaded
E001123-01-111 SHT 3 & SHT 1	2	2"-HG-BLOWDOWN-1-C12	Sour Hydrocarbon gas	2"	xs	1"-HG-BLOWDOWN-1-C11	4"-HG-VENTHEADER-1-C12	C12	150	230	300	1/8"	400	Hydro	100%	SA-106-B	SA-105N	N	YES	
E001123-01-111 SHT 1	2	1/2"-HG-PSV-1201-1-C11	Sweet Hydrocarbon gas	2" / 1/2"	STD (40) XS	Suction Filter 5V-4211	PSV-1101	C11	150	230	300	1/16"	253	Pneumatic	N/A	SA-106-B	SA-105N	N	N/A	Threaded
E001123-01-111 SHT 1	2	2"-HG-PSV-1201-1-C11	Sour Hydrocarbon gas	1" / 2"	xs	PSV-1101	4"-HG-VENTHEADER-1-C12	C12	150	230	300	1/16"	253	Pneumatic	N/A	SA-106-B	SA-105N	N	N/A	Threaded
E001123-01-111 SHT 2 & SHT1	2	4"-HG-PSV-1201-1-C12	Sour Hydrocarbon gas	4"/ 2"/ 1 1/2"	STD (40) XS	PSV-1201	4"-HG-VENTHEADER-1-C12	C12	150	230	300	1/8"	400	Hydro	100%	SA-106-B	SA-105N	N	YES	٠
E001123-01-111 SHT1	2	4"-HG-VENTHEADER-1- C12	Sour Hydrocarbon gas	4"	STD (40)	4"-HG-PSV-1201-1-C12	High pressure vent connection 6	C12	150	230	300	1/8"	400	Hydro	100%	SA-106-B	SA-105N	N.	YES	
E001123-01-111 SHT1	2	1"-HL-5V-4211-1-C11	Sweet Hydrocarbon Liquid	2"-1 1/2'-1"	XS	Suction Filter 5V-4211	Pressurized Hydrocarbon Drain connection 4	C11	150	230	300	1/16"	253	Pneumatic	N/A	SA-106-B	SA-105N	N	N/A	Threaded
E001123-01-111 SHT1	2	1"-IA-INLET-1-C11	Instrument air	1"	xs	Instrument air inlet connection 3	Various Instruments	C11	150	230	300	1/16"	253	Pneumatic	N/A	SA-106-B	SA-105N	N	N/A	Threaded
E001123-01-111 SHT 3	2	1/2"-L-5V-4236-1-C11	Oil	1" / 3/4" / 1/2"	XS	5V-4236	Compressor Coalescer Bleed SD-1	C11	150	230	300	1/16"	253	Pneumatic	N/A	SA-106-B	SA-105N	N	N/A	Threaded


											Po	visions				ī		PRO	FESSIONAL F	NGINEER STAMP
LINE		CT					N (1999 € 23 mile to 4000 + 0.00		NO.	ISSI		DATE	By	Checked	Approved				FNGU	ME
LINE		3 I		Customer:		MEG	Energy		1	For Regi		16/03/2015	Nika Rezaeyan		AFF.				EMON	TEEN
TABLE TRANSPORTED TO THE PARTY OF THE PARTY															Mes	NOTE: THE FLOW DRAWIN		1.5	ND EC	ENT OF THE
Document Vers	ion 0, 2	22-Sept-2014				1500 BPD	HI-Q FD Pilot									HAVE BEEN P. ENG STAI ORIGINAL PACKAGE	130	J. Alon	1000 N	
				Project:			as Compressor									FABRICATION, ENERFLEX		1.9/	E C.	\X\\\\\\\\\\\\\\\\\\\\\\\\\\\\\\\\\\\\
				r roject.			(-1401									FOR THE CHANGES THAT		10018	1	1/121
	No.					5r	₹-1401						856			DURING THE FIELD IN	ISTALLATION AND	1001/	1 44	
		RFL														OPERATION O	F THE UNIT	LELS !	1114	A 131
				EFX Job #:		E00	1123-01									-		12	in the	4 15:2
														-		1		10		
				<u></u>				COMMON CONTRACTOR OF THE CONTR		ł								10	1100	3137
										ļ				-		APEGA PERM	/IT # D0651	10000	1106	
																ALCATER	mr	/	VIOUR	19,2015
				1			1										T		ı T	
	P&ID				PIPE	FROM	то	2125 2252		DESIGN	DESIGN	C.A.	TEST	TYPE OF	V DAY (0/)	PIPE MATERIAL	FLANGE MATERIAL	IMPACT	PWHT	NOTES
P&ID	Rev.	Line Number	SERVICE	SIZE (INCH)	SCHEDULE		****	PIPE SPEC	ANSI CLASS	PRESSURE (psig)	TEMP. (°F)	(INCH)	PRESSURE (psig)	TEST	X-RAY (%)	PIPE WATERIAL	FLANGE WATERIAL	TEST (Y/N)	(Y/N)	NOTES
										(þsig)		- 10 N	(psig)							
E001123-01-111																				1
SHT 2,	2	3"-L-5V-4236-1-C11	Oil	3"	STD (40)	Oil separator 5V-4236	Oil cooler 5E-3101,	C11	150	230	300	1/16"	400	Hydro	10%	hallocate about the state of	SA-105N	l N	l N l	i
E001123-01-113		3 -L-3V-4230-1-C11	Oil	3	310 (40)	Oil separator 5V-4250	TCV-3101	OH	150	250	300	1710	400	Tiyaro	1070	SA-106-B	Or Crook	5.0.8	, "]	i
SHT 1		()																		
E001123-01-113								69. 11		2000		**********			2000000		18 - ANT THE - TO ANT - SPACE	14/2011	1	i
SHT 1	2	3"-L-5E-3101-1-C11	Oil	3"	STD (40)	Oil cooler 5E-3101	TCV-3101	C11	150	230	300	1/16"	400	Hydro	10%	SA-106-B	SA-105N	N	N	İ
OHI I																				
E004402 04 442							Luba ail filtara EE 3101 A/B													
E001123-01-113 SHT 1	2	3"-L-5E-3101-2-C11	Oil	3" / 2"	STD (40)	TCV-3101	Lube oil filters 5F-3101A/B, 2"-L-5E-3101-2-C11	C11	150	230	300	1/16"	400	Hydro	10%	SA-106-B	SA-105N	N	N	1
oni i							2 -L-3E-3101-2-011													
																	1			1
E001123-01-113 SHT 1	2	2"-L-5E-3101-2-C11	Oil	2"	STD (40)	3"-L-5E-3101-2-C11	Compressor main oil injection SM-1	C11	150	230	300	1/16"	400	Hydro	10%	SA-106-B	SA-105N	N	N	l .
5111							SIVI-1													I
		1 1																		
E001123-01-113	2	3"-L-5F-3101A/B-1-C11	Oil	2"/ 3"	STD (40)	Lube oil filters 5F-3101A/B,	Oil Header End	C11	150	230	300	1/16"	400	Hydro	10%	SA-106-B	SA-105N	N	N	1
SHT 1		THE TAX PRODUCT WEST CONTROL OF SECUNDARY	2000	65000 00	000000000000000000000000000000000000000			-						273		1965 1100 909 343				1
ALLOCAL TOURS AND				2												0				ĺ
E001123-01-113	2	1 1/2"-L-5F-3101A/B-1-C11	Oil	1 1/2"	xs	3"-L-5F-3101A/B-1-C11	Compressor oil supply SB-3	C11	150	150	300	1/16"	165	Pneumatic	N/A	SA-106-B	SA-105N	N	N/A	Threaded
SHT 1	****	A CONTRACTOR OF THE STANDARD STANDARD CONTRACTOR AND A CO	Wednesday.	90,000,000		where the receive we was appropriated and with the second memory and it was a transformation to the	The second secon	ALIMANT THE				555575450		1 1 1 1 1 1 1 1 1 1 1 1 1 1 1 1 1 1 1 1		Andreas at Alberta Strome other			ļ	
7							PSV LIST				***************************************							200 W 100 W	TES	
PSV TAG#		P&ID	P&ID Rev.	MAKE		MODEL#	INLET SIZE (inch)	OUTLET SIZE (inch)	SET POINT (psig)				VESSELS PRO	TECTED			All piping designed to EFX Pipe Spec C11 a	ind C12 were	followed.	s otherwise noted.
A2022421078800	02		120	12 13	1		İ	The contract					0	27.4044			All spools are buttwel	d unless other	wise notes.	
PSV-1101	E	E001123-01-111 SHT 1	2	Farris		27CA13-M20/S7	1/2" MNPT	1" FNPT	230	1			Suction Filter 5	V-4211						
201/1001		5004400 04 444 OUT 0	_	F	İ	2004404 400/07	4 4 1011 4 50 41 D.F.	01 4 F 0 # D F	1 000	1		VI Caparata-	5V-4236, Process	Con Contra	Coation AC		7			
PSV-1201		E001123-01-111 SHT 2	2	Farris		26GA10A-120/S7	1 1/2" 150# RF	3" 150# RF	230		,	on Separator	5v-4236, P100ess	s Gas Cooler S	DECLIOIT AC					

General Arrangements


EFX Document Number: C07-E001123-01-201-001

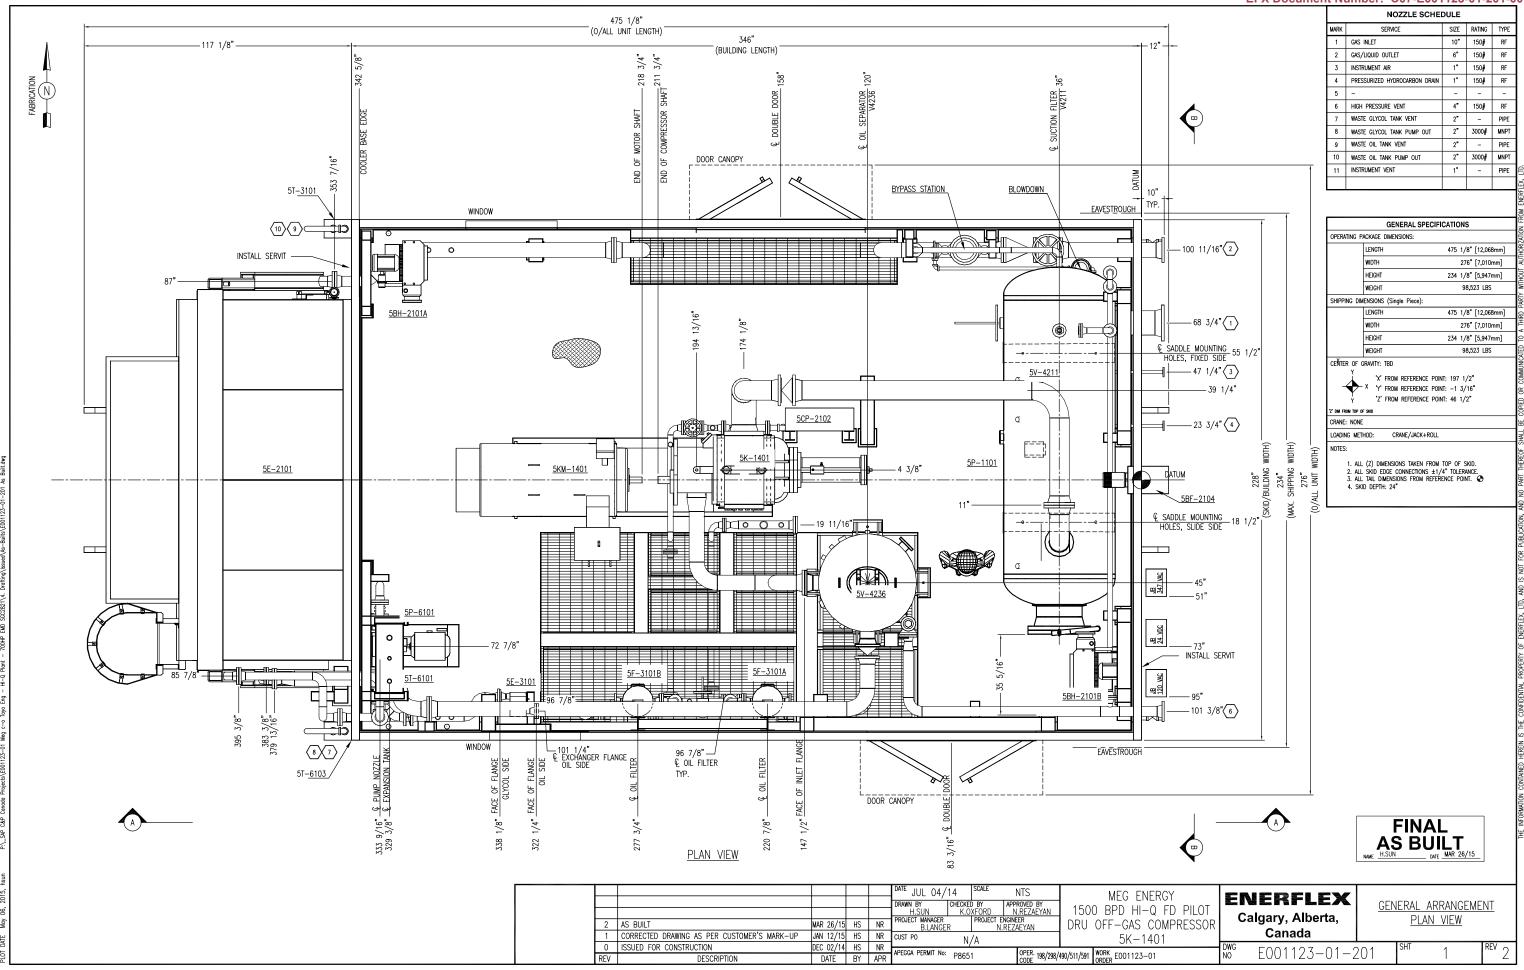

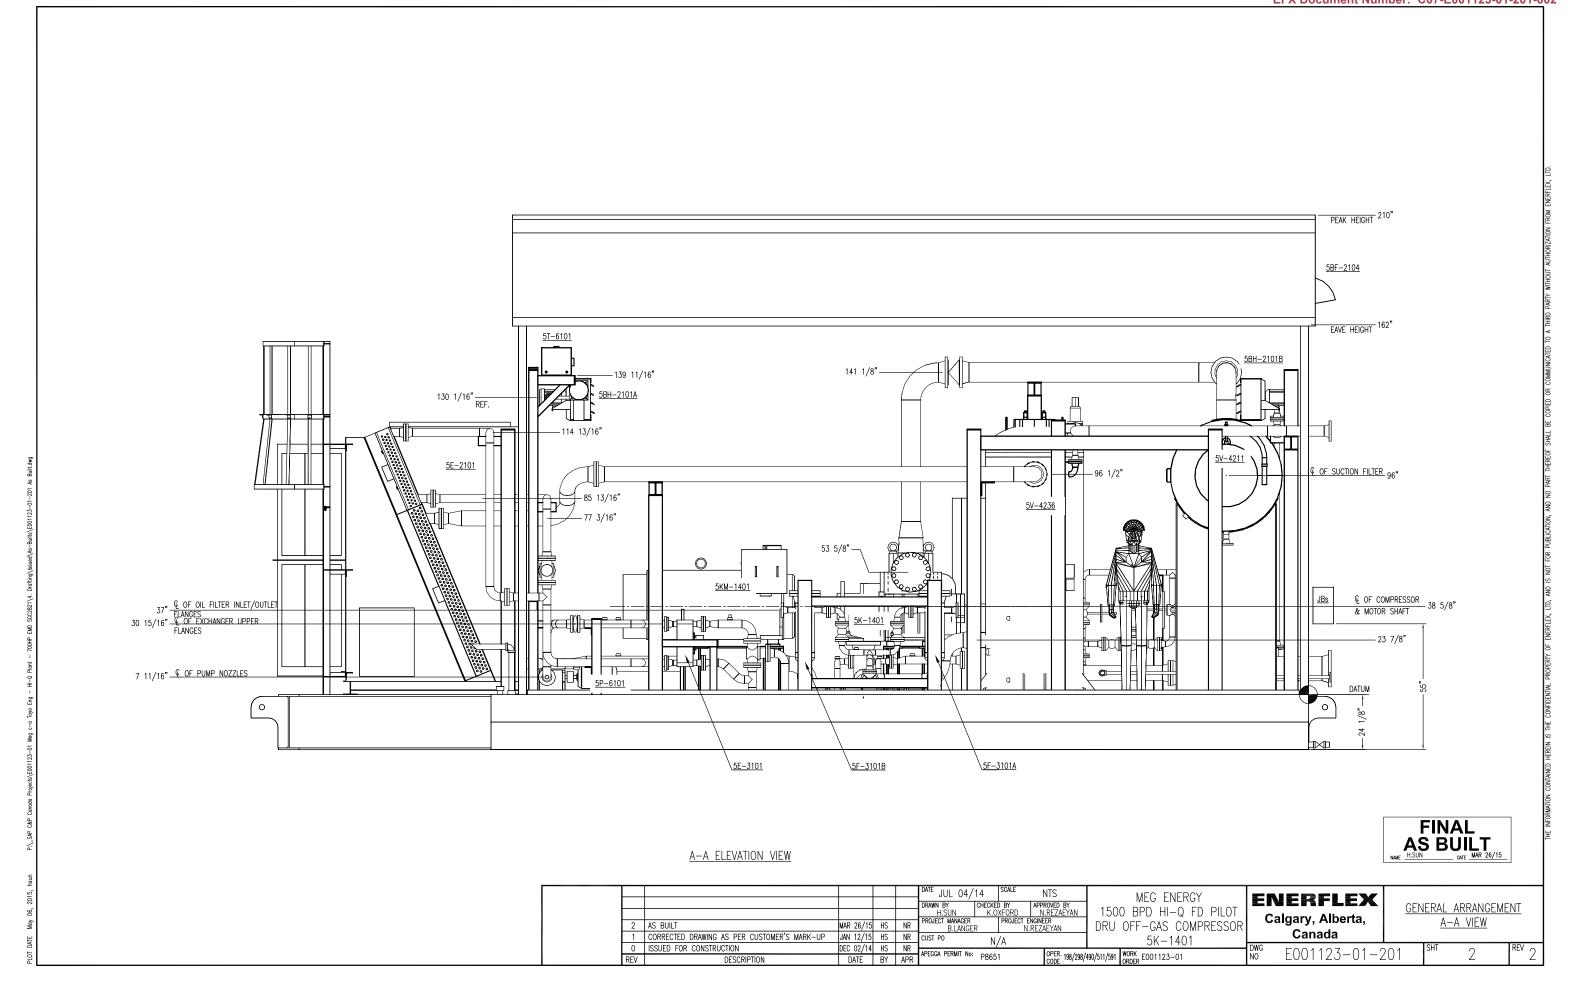


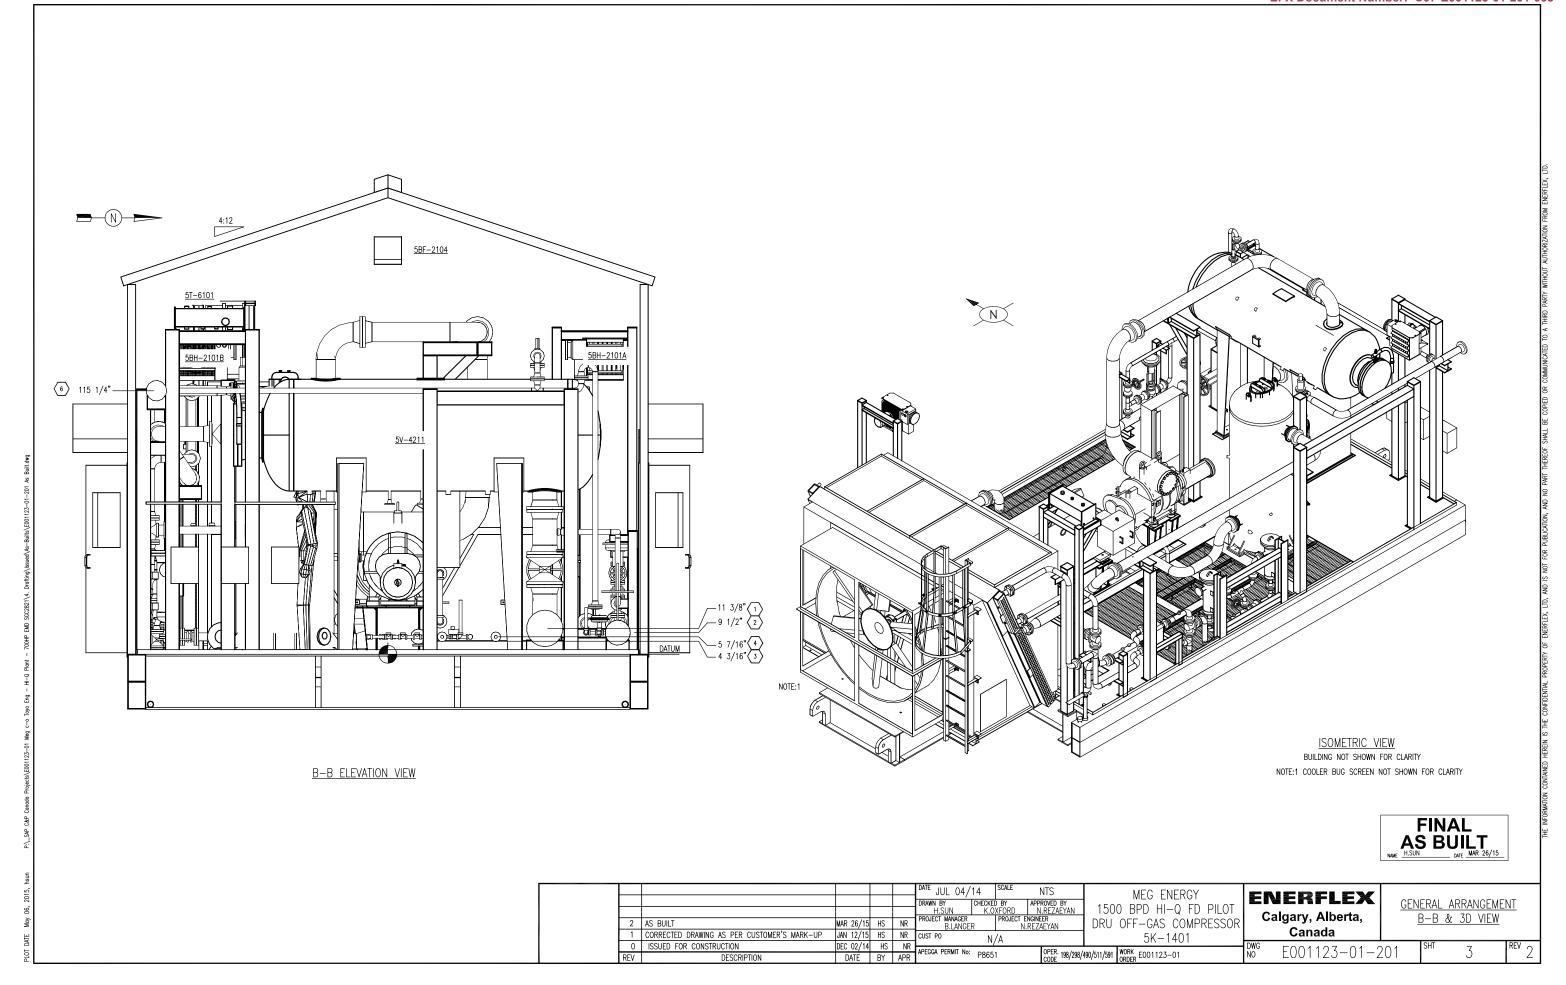



Pile / Anchor Bolt Diagram

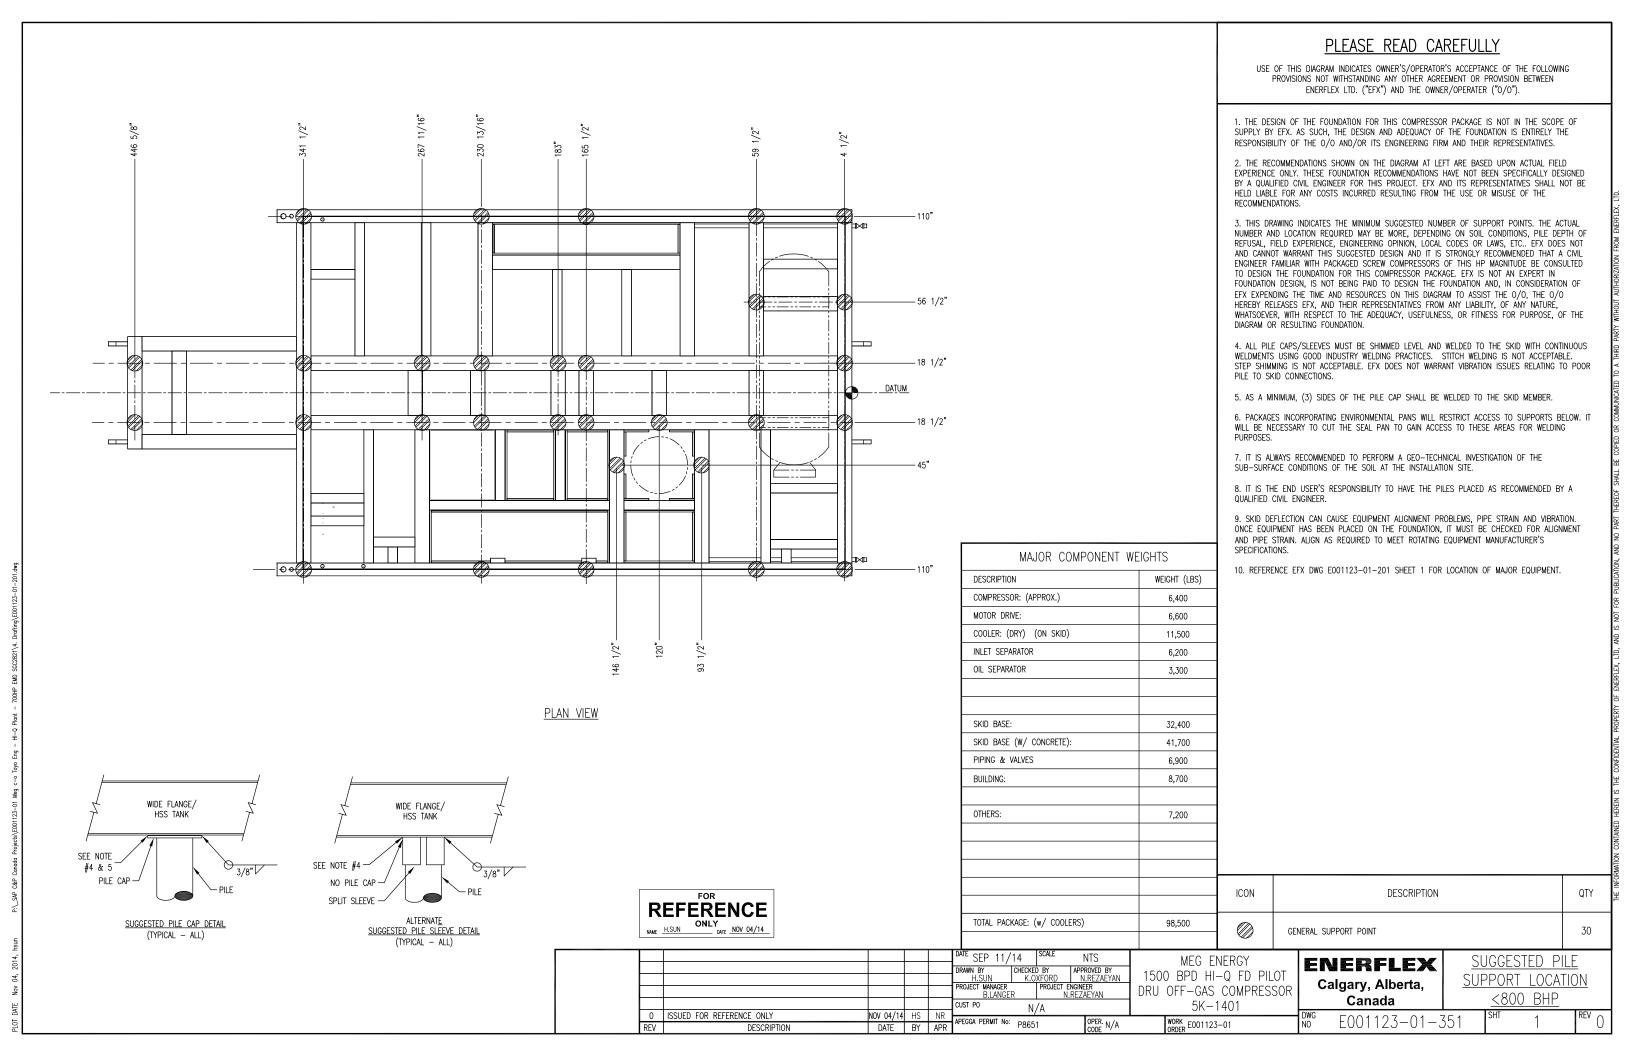

Structural Steel

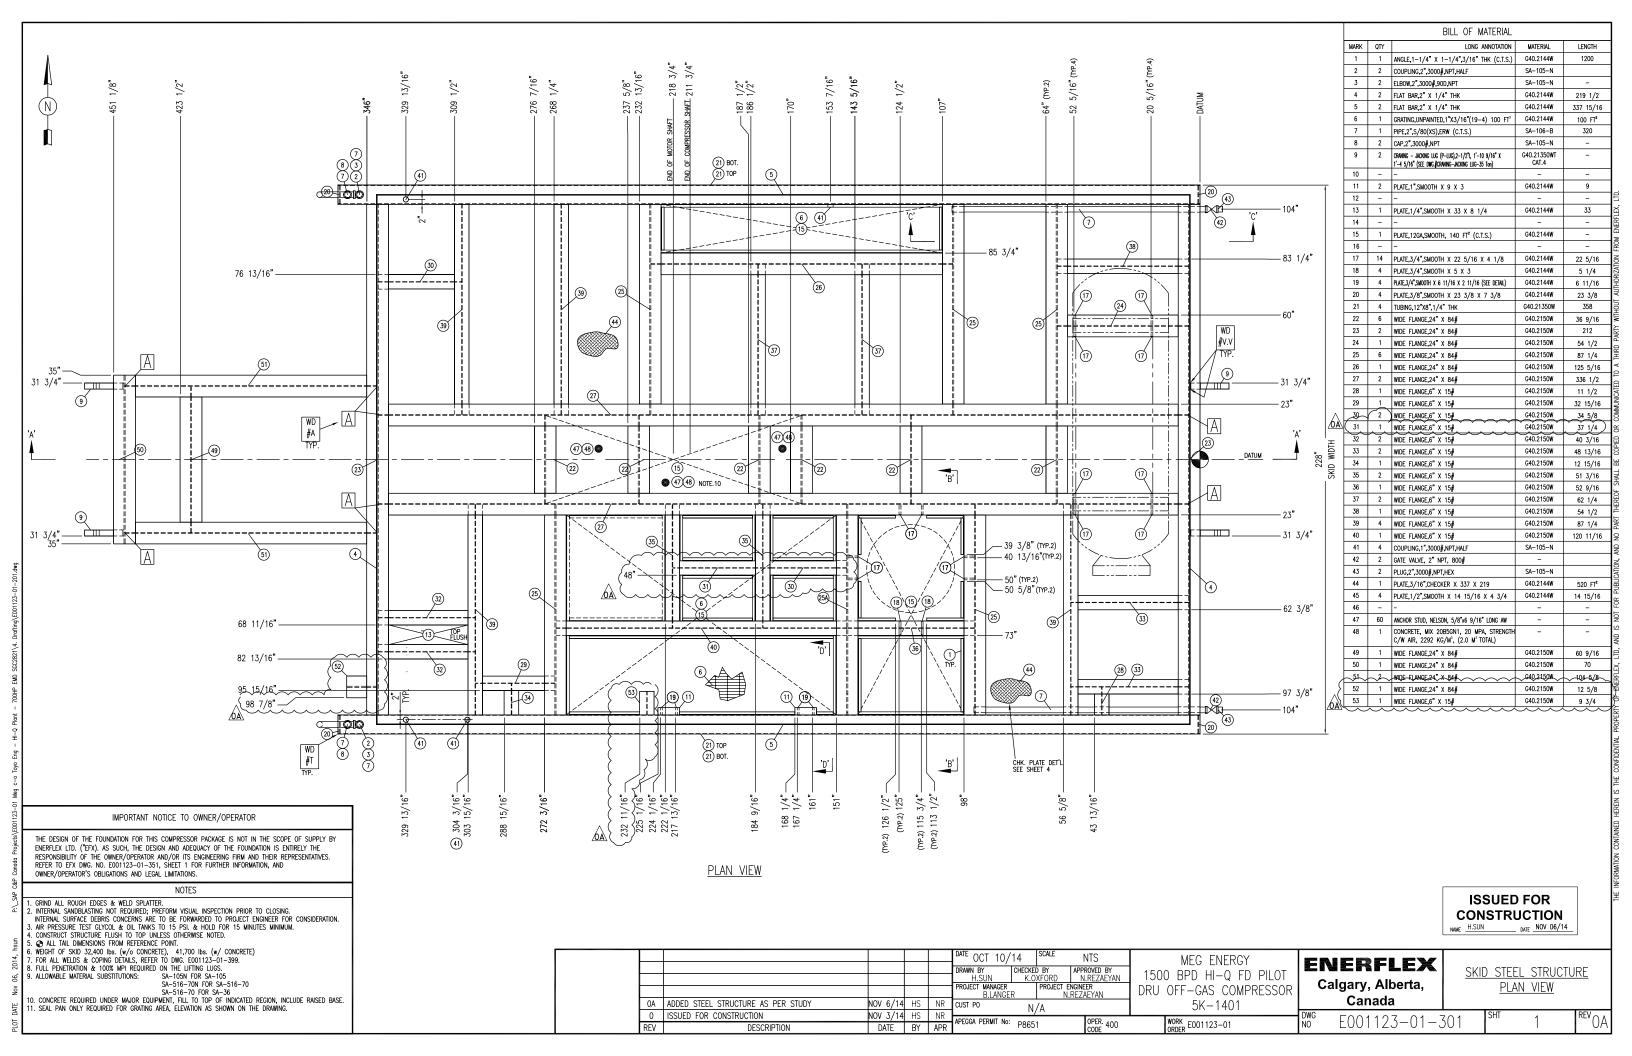

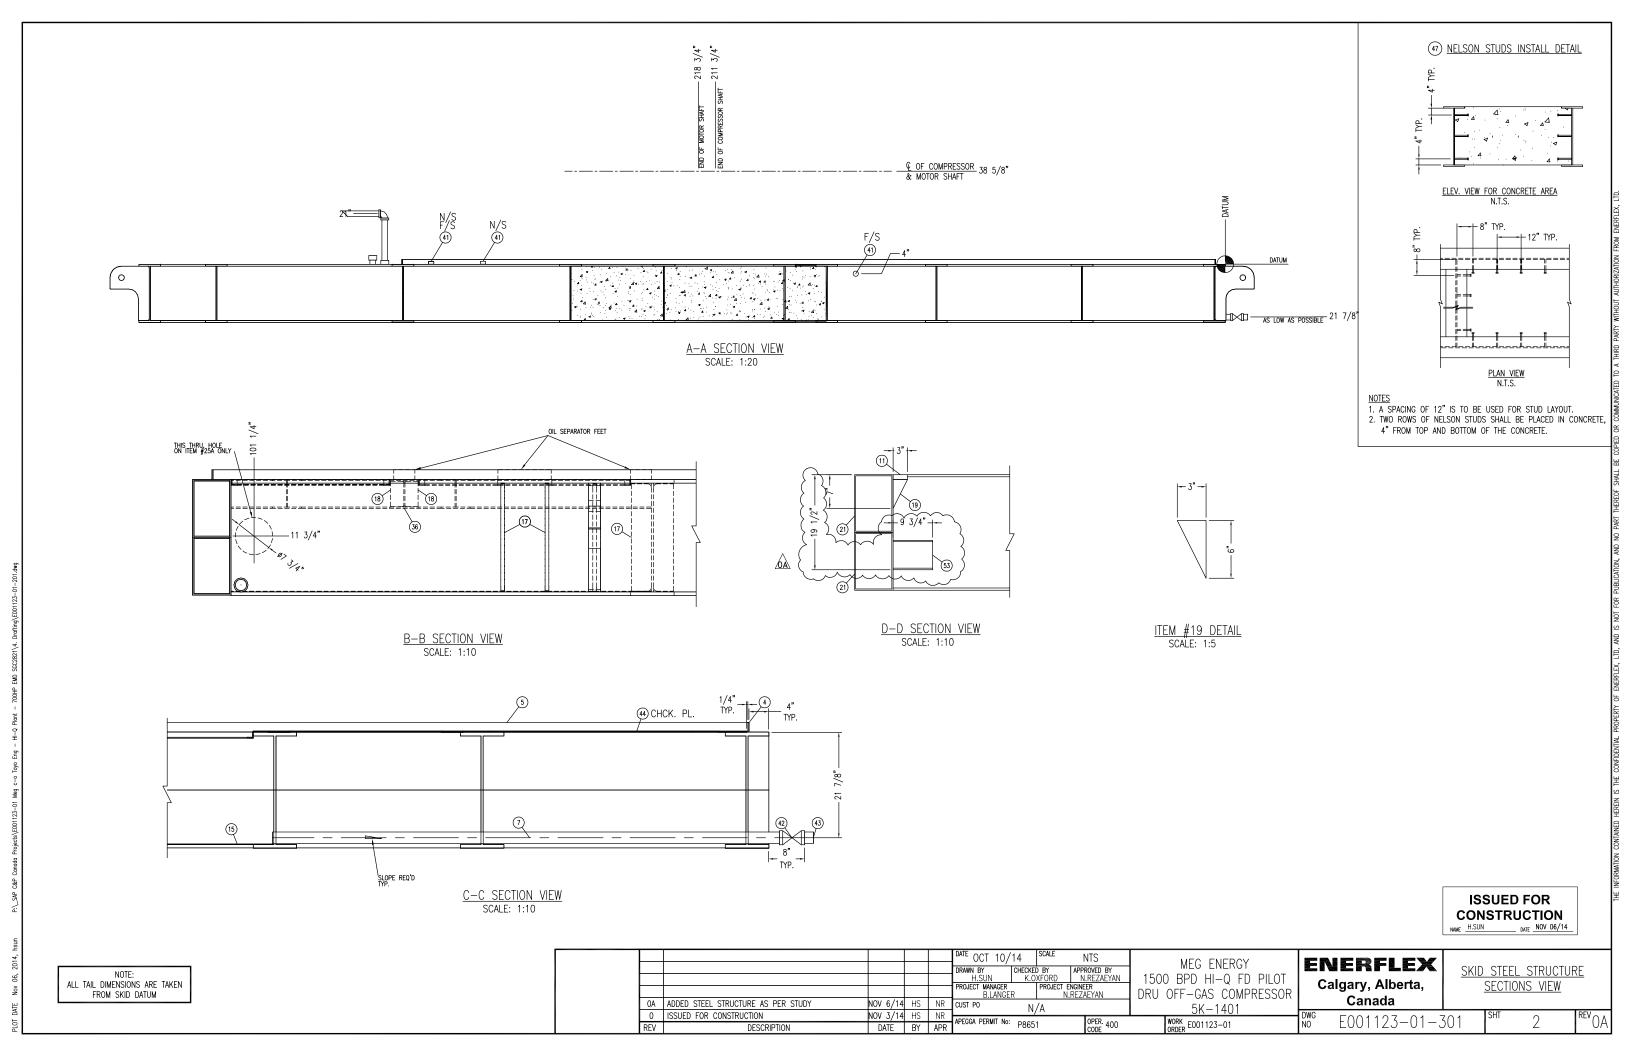

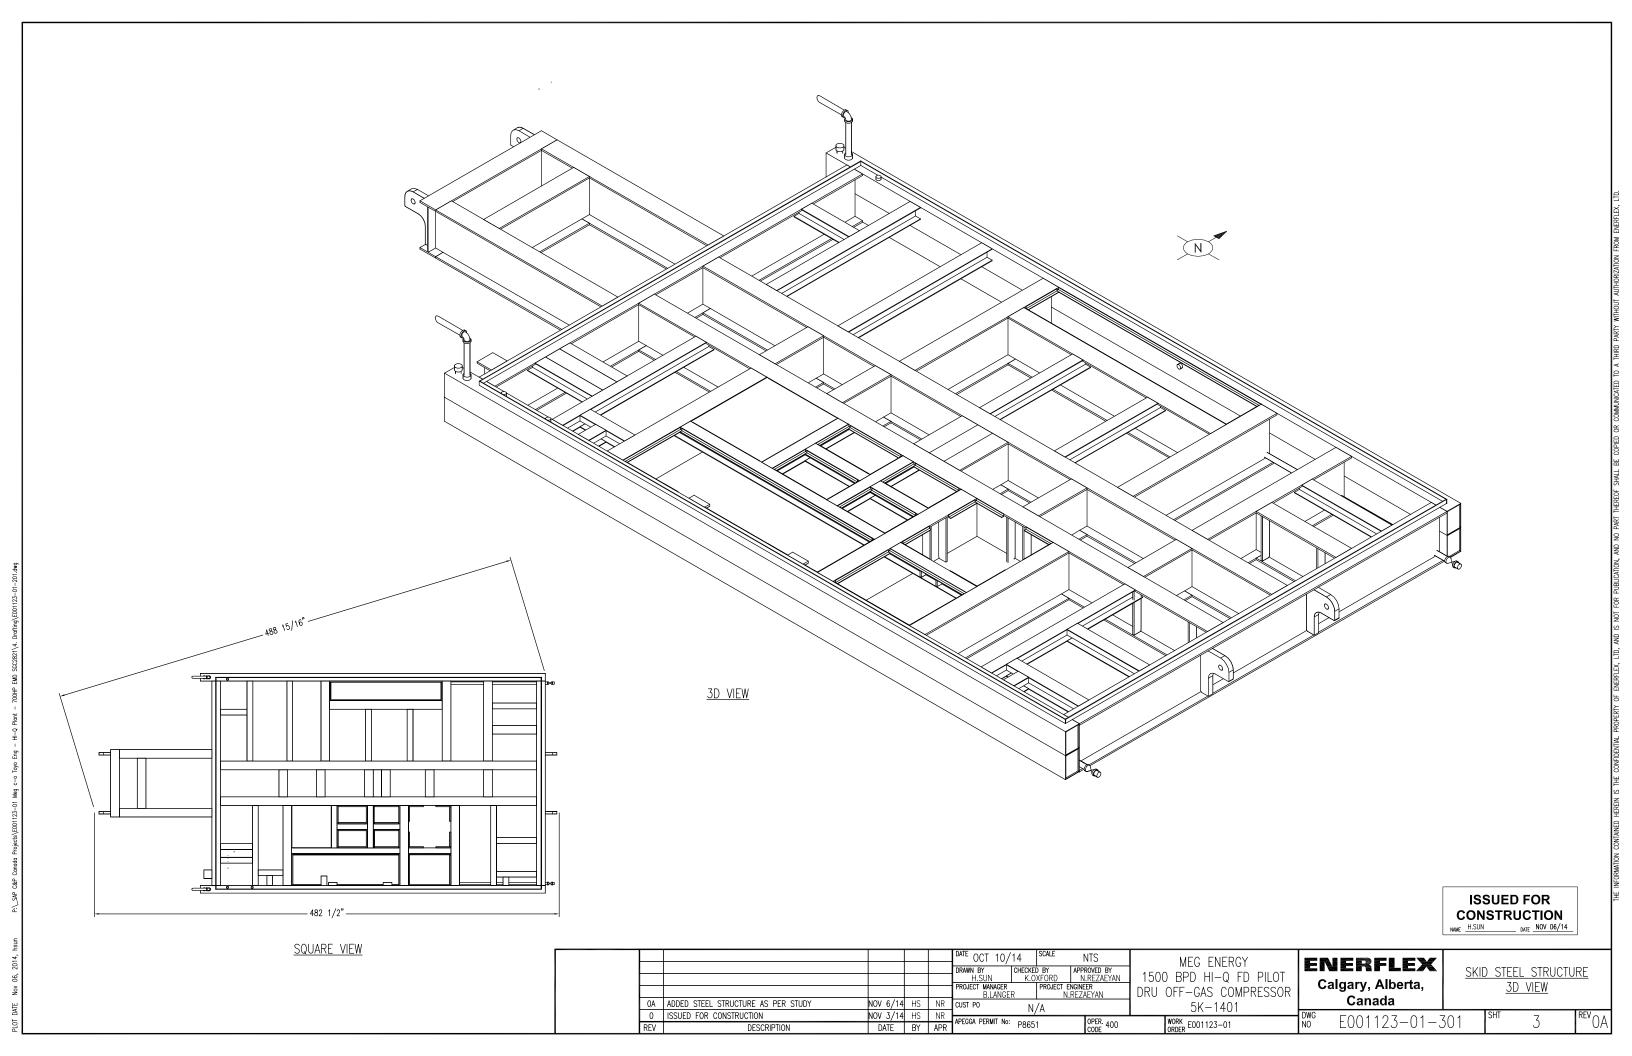

Building Drawing(s)

